**PROJECT** 

# MT PLEASANT UNISTONE & MEMORIAL PLAZA

**LOCATION** 

**PROJECT ADDRESS** MOUNT PLEASANT CEMENTERY 5420 106 ST N.W. EDMONTON, AB T6H 2S9

**LEGAL ADDRESS** 

PLAN 0022393; BLOCK 33; LOT 17

### **SCOPE OF WORK**

- NEW PLAZA
- LANDSCAPING, HARDSCAPING, AND PLANTING WITHIN THE GARDEN AREA

#### **CLIENT**



City of Edmonton 10111 - 104 Avenue NW Edmonton, Ab

www.edmonton.ca 780.442.5311

### **STRUCTURAL**



Ethos Engineering 8526 109 St NW #2 Edmonton, AB T6G 1E5

www.ethos-engineering.com (780) 436-2992

340 12th Avenue SW Calgary, AB



Williams Engineering N195, 3015 - 5 AVE NE Calgary, AB

Lemay + Toker is a trade name owned and used by Toker + Associates Architecture Industrial Design Ltd.

**PRIME CONSULTANT** 

lemay+TOKER

T2R 1L5

www.lemaytoker.com (403) 245 - 3089


CIVIL



T2A 6T8

www.williamsengineering.com (403) 263-2392

### STRUCTURAL

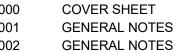

LANDSCAPE

SITE DEMO, TREE PROTECTION- PROJECT SITE A GRADING & LAYOUT PLANS - PROJECT SITE A


PLANTING PLAN & SITE DETAILS - PROJECT SITE A SITE DEMOLITION - PROJECT SITE B


GRADING & LAYOUT PLAN - PROJECT SITE B PLANTING PLAN - PROJECT SITE B

DETAILS - PROJECT SITE A DETAILS - PROJECT SITE A DETAILS - PROJECT SITE A

L-203 SITE SECTIONS AND DETAILS - PROJECT B GENERAL NOTES ISOMETRIC FOUNDATION PLAN



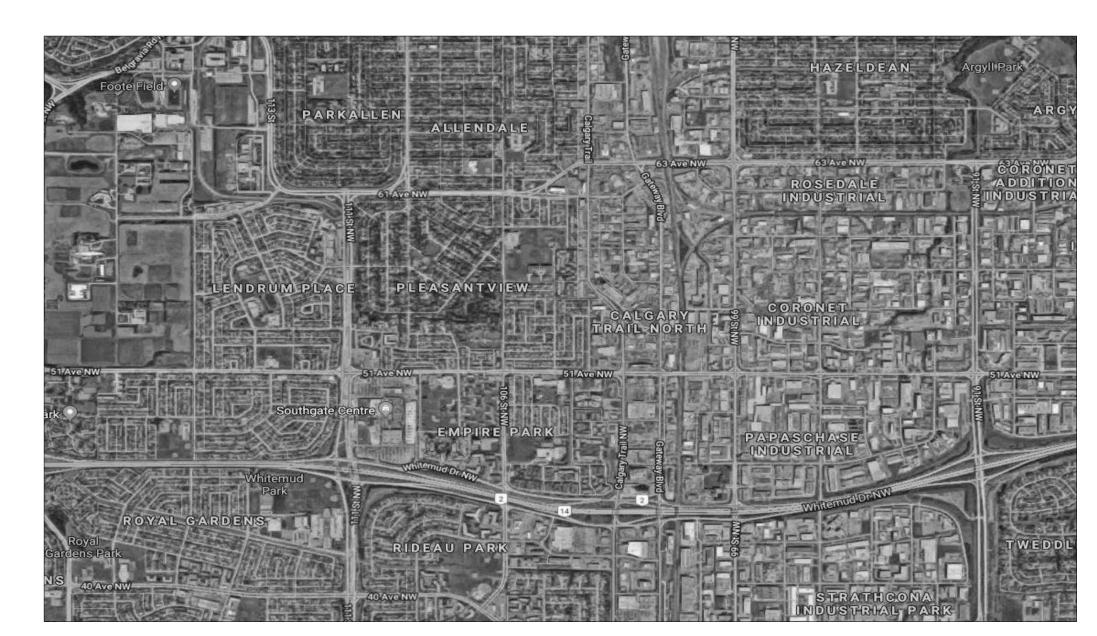

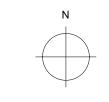

**ZONING MAP** 

**GENERAL** 

ARCHITECTURE

S1-01 SECTIONS

THE COE LANDSCAPING SECTION APPLIES TO THIS PROJECT AND INCLUDES THE FOLLOWING RELATED SECTIONS -

- DESIGN AND CONSTRUCTION STANDARDS VOLUME 2: ROADWAYS, SECTION 02335 - SUBGRADE PREPARATION (OF NEW UNISTONE AREAS AND RAIN GARDEN PLANTING BEDS);
- DESIGN AND CONSTRUCTION STANDARDS VOLUME 5: LANDSCAPING, SECTION 02910 - TOPSOIL (GROWING MEDIUM FOR RAIN GARDEN PLANTING BEDS);
- **DESIGN AND CONSTRUCTION STANDARDS VOLUME 5:** LANDSCAPING, SECTION 02914 – MULCHES (PINE BARK CHUNK-TYPE MULCH FOR RAIN GARDEN PLANTING BEDS);
- DESIGN AND CONSTRUCTION STANDARDS VOLUME 5: LANDSCAPING, SECTION 02930 – TREES, SHRUBS AND GROUNDCOVERS (FOR PLANTING OF RAIN GARDEN AREAS).

#### THE WORD "CONTRACTOR" REFERS EQUALLY TO A GENERAL CONTRACTOR

- OR A CONSTRUCTION MANAGER. THE WORD "CONSULTANT" OR "DESIGNER" REFERS TO THE ARCHITECT
- LANDSCAPE ARCHITECT OR ENGINEER WHO PREPARED THE CONTRACT THE WORD "OWNER" OR "CITY CONSULTANT" REFERS TO THE CLIENT (CITY
- OF EDMONTON) WHO THE DOCUMENTS ARE PREPARED FOR. THE WORDING "CODE" REFERS TO MEETING OR EXCEEDING THE REQUIREMENTS OF THE 2006 ALBERTA BUILDING CODE, ALL MUNICIPAL

BYLAWS, CODES, ORDINANCES, GUIDELINES, AND THE AUTHORITIES HAVING

JURISDICTION.

- CONTRACTOR SHALL UNDERTAKE AND EXECUTE ALL WORK TO MEET OR EXCEED THE REQUIREMENTS OF THE LATEST VERSION OF THE ALBERTA BUILDING CODE, ALL MUNICIPAL BYLAWS, CODES, ORDINANCES, GUIDELINES, AND THE AUTHORITIES HAVING JURISDICTION.
- ALL WORK SHALL BE GUARANTEED FOR A MINIMUM PERIOD OF 2 YEARS, UNLESS NOTED OTHERWISE.
- THIS CONTRACT IS FOR A COMPLETE LANDSCAPE CONSTRUCTION COORDINATION OF ALL RELATED TRADES. THE CONTRACT DOCUMENTS ARE COMPLEMENTARY AND WHAT IS REQUIRED BY ANY ONE SHALL BE AS BINDING AS IF REQUIRED BY ALL
- CONTRACTOR SHALL BE RESPONSIBLE FOR PERMITS & INSPECTIONS REQUIRED BY THE AUTHORITY HAVING JURISDICTION AND AFTER COMPLETION OF WORK. PRIOR TO CONSTRUCTION COMPLETION FORWARD A COPY OF ALL REQUIRED VERIFICATIONS AND CERTIFICATES TO CONSULTANT.
- CONTRACTORS SHALL CHECK SITE PRIOR TO SUBMITTING TENDERS AND INCLUDE FOR ALL WORK NECESSARY FOR A COMPLETE INSTALLATION.
- ANY ERRORS, OMISSIONS OR DISCREPANCIES IN DRAWINGS SHALL BE BROUGHT TO THE ATTENTION OF THE CONSULTANT IMMEDIATELY. CONTRACTOR SHALL CONFIRM ALL DIMENSIONS ON SITE PRIOR TO CONSTRUCTION. NO CONTRACT REVISIONS OR EXTRAS WILL BE ALLOWED FOR FAILURE TO VERIFY SITE CONDITIONS & DIMENSIONS.
- CONTRACTOR SHALL COMPLY WITH THE RULES & REGULATIONS FOR CONSTRUCTION WITHIN THE SITE AS SET OUT BY THE OWNER TO MEET TYPICAL DEVELOPMENT STANDARDS.
- CONTRACTOR SHALL BE RESPONSIBLE TO OBTAIN AND FAMILIARIZE THEMSELVES WITH THE CONSTRUCTION AND SITE ACCESS, PARKING AND LOCAL BUSINESS LICENSING AND INCLUDE SUCH COSTS IN CONTRACT.
- COORDINATE WORK WITH THE CITY CONSULTANT. ANY WORK WHICH MAY DISRUPT OTHER MOUNT PLEASANT CEMETERY ACTIVITY SHALL BE DISCUSSED WITH THE CITY CONSULTANT PRIOR TO COMMENCEMENT OF WORK. CONTRACTOR TO ENSURE CONTAMINANTS ARE NOT SPREAD TO ADJACENT AREAS OR PUBLIC SPACES.
- PROVIDE EROSION AND SEDIMENTATION CONTROL AND RELATED PROTECTIVE MEASURES AT DEMOLITION AND NEW CONSTRUCTION TO ENSURE NO CONSTRUCTION DUST OR DEBRIS ENTERS OTHER MOUNT PLEASANT CEMETERY AREAS.
- CONTRACTOR TO MAKE SURE TO CLEAN AND MAINTAIN THE PROJECT AREA DURING CONSTRUCTION TO ENSURE IT IS FREE FROM ACCUMULATION OF WASTE AND DEBRIS. CLEAN AND DISPOSE OF WASTE AND DEBRIS ON A DAILY BASIS. CONFIRM WITH CITY CONSULTANT THE APPROVED METHOD OF DEBRIS REMOVAL AND POSSIBLE LOCATION OF GARBAGE BINS.
- CONTRACTOR SHALL MAKE GOOD TO AS NEW CONDITION AND PROTECT ALL EXISTING CONSTRUCTION AND FINISHES WHICH ARE TO REMAIN. REPAIR AND MAKE GOOD, TO AS NEW CONDITION ALL SURFACES EFFECTED BY DEMOLITION OR NEW CONSTRUCTION.
- INSTALL ALL NEW MATERIALS AND EQUIPMENT PER MANUFACTURER'S WRITTEN INSTRUCTIONS.
- WHERE SPECIFIC MATERIALS ARE NOT SPECIFIED, THE CONTRACTOR IS TO PROVIDE SAMPLES OF ALL NEW MATERIALS REQUIRED FOR CONSULTANT'S
- ALL MATERIAL TO BE AS SPECIFIED OR CONSULTANT REVIEWED ALTERNATES. PROPOSED ALTERNATES ARE TO BE INDICATED IN PRICING AND SUBMITTED TO CONSULTANT FOR REVIEW PRIOR TO TENDER CLOSING AND ORDERING.
- CONTRACTOR SHALL COORDINATE FINAL INSPECTION DATE WITH CONSULTANT PRIOR TO USE OF NEW UNISTONE PAVING AND RAIN GARDEN TRAIL AREAS.
- ALL DEFICIENCIES ARE TO BE COMPLETED BY THE CONTRACTOR WITHIN 30 DAYS AFTER SUBSTANTIAL COMPLETION.
- COORDINATE WORK OF ALL TRADES AND SUBCONTRACTORS TO AVOID INTERFERENCE AND EXPEDITE PROGRESS. NOTIFY TRADES AND SUBCONTRACTORS OF READINESS FOR THEIR WORK, TO ALLOW ADEQUATE TIME FOR INSTALLATION WITHOUT DELAYING COMPLETION OF THE PROJECT.
- EXECUTE ALL WORK TO MEET OR EXCEED THE REQUIREMENTS OF THE CURRENT VERSION OF THE CITY OF EDMONTON DESIGN AND CONSTRUCTION STANDARDS VOLUME 5 LANDSCAPING, ALL MUNICIPAL BYLAWS, CODES, ORDINANCES, GUIDELINES, AND THE AUTHORITIES HAVING JURISDICTION.

#### GENERAL NOTES CONTINUED:

#### SHOP DRAWINGS & SUBMITTALS:

- THE CONTRACTOR TO SUBMIT ELECTRONIC SHOP DRAWINGS IN PDF FORMAT TO CONSULTANT FOR REVIEW PRIOR TO FABRICATION. PROVIDE SHOP DRAWINGS FOR ALL EQUIPMENT, GRAPHICS & NEW PRODUCTS REQUIRED TO
- PROVIDE THREE SAMPLES OF ALL NEW MATERIALS & FINISHES (INCLUDING THOSE SPECIFIED TO MATCH EXISTING) TO THE CONSULTANT FOR REVIEW.
- DELIVER SAMPLES AND OTHER SUBMITTALS TO THE CONSULTANT'S EDMONTON BUSINESS ADDRESS. SUBMIT WITH A REASONABLE PROMPTNESS AND IN AN ORDERLY SEQUENCE SO AS NOT TO CAUSE DELAY TO THE WORK. DO NOT PROCEED WITH FABRICATION, MANUFACTURE, ORDERING OR
- CONSTRUCTION PRIOR TO REVIEW BY THE CONSULTANT. DO NOT PROCEED WITH THE WORK AFFECTED BY THE SUBMITTAL UNTIL REVIEW IS COMPLETE.
- INDICATE MATERIALS, METHODS OF CONSTRUCTION AND ATTACHMENT OR ANCHORAGE, CONNECTIONS, EXPLANATORY NOTES AND OTHER INFORMATION NECESSARY FOR REVIEW.
- THE WORK OF THIS PROJECT AS INDICATED ON THE DRAWING IS IN METRIC UNITS. ALL SHOP DRAWINGS TO BE SUBMITTED IN UNITS TO MATCH THE UNITS USED IN THE DRAWINGS.
- ADJUSTMENTS MADE ON SHOP DRAWINGS ARE NOT INTENDED TO CHANGE THE CONTRACT PRICE. IF THE ADJUSTMENTS AFFECT THE CONTRACT PRICE, THE CONTRACTOR SHALL NOTIFY THE CONSULTANT IN WRITING, PRIOR TO
- THE CONSULTANT RESERVES THE RIGHT TO REVISE THE SHOP DRAWINGS AS MAY BE REQUIRED.
- ALL IMAGE AND/OR GRAPHICS PREPARATION SHALL BE THE RESPONSIBILITY OF THE CONTRACTOR. CONSULTANT'S DESIGNER IS NOT RESPONSIBLE FOR PROVIDING ORIGINAL DESIGN FILE.
- FULL SIZE SAMPLE OF ALL IMAGES AND/OR GRAPHICS MUST BE SUBMITTED TO THE DESIGNER AND CLIENT FOR APPROVAL
- ALL IMAGES AND/OR GRAPHICS MUST BE APPROVED BY THE CLIENT PRIOR TO FABRICATION AND INSTALLATION.

CONTRACTOR TO KEEP ONE SET RECORD DRAWINGS ON SITE AT ALL TIMES AND TO MARK UP ANY CHANGES IN THE WORK ON THESE DRAWINGS. AT SUBSTANTIAL COMPLETION SUBMIT ONE (1) PAPER COPY AND ONE (1) SCANNED IN USB OF ALL CONTENTS OF THE RECORD SET OF DRAWINGS IN PDF FORMAT TO THE CONSULTANT. PDF TO HAVE A TABLE OF CONTENTS AND TO BE BOOK MARKED.

#### **OPERATION AND MAINTENANCE MANUALS:**

- AT SUBSTANTIAL PERFORMANCE OF THE WORK, CONTRACTOR TO SUBMIT TO THE CONSULTANT AN OPERATIONS AND MAINTENANCE MANUAL: TWO (2) PAPER COPIES, IN A 3-RING BINDER, WITH A TABLE OF CONTENTS, AND
  - TWO (2) SCANNED IN USB'S OF ALL CONTENTS OF THE BINDER IN PDF FORMAT.
- PDF'S TO HAVE A TABLE OF CONTENTS AND TO BE BOOK MARKED CONTAINING THE FOLLOWING
- FOR ALL NEW MATERIALS AND EQUIPMENT, MANUFACTURER'S WRITTEN MAINTENANCE GUIDES, CARE & CLEANING INSTRUCTIONS, PARTS LISTS, A LIST OF ALL INSTALLED HARDWARE WITH A SCHEDULE, A LIST OF FINISH MATERIALS, AND A COPY OF ALL **GUARANTEES AND WARRANTEES ISSUED.**

- PROVIDE 2% EXTRA MATERIAL FOR MAINTENANCE PURPOSES, INCLUDING THE FOLLOWING:
  - ROMAN UNISTONE PAVERS LINEAR EDGE PAVERS

#### PROGRESS MEETINGS:

- THE CONTRACTOR SHALL SCHEDULE AND ADMINISTER PROJECT PROGRESS MEETINGS THROUGHOUT THE WORK ON A WEEKLY BASIS AS REQUIRED TO ENSURE EFFICIENT PROGRESS OF THE WORK. THE CONTRACTOR SHALL RECORD THE MINUTES AND DISTRIBUTE COPIES TO THE PARTICIPANTS, AFFECTED PARTIES NOT IN ATTENDANCE, AND THE OWNER.
- CONTRACTOR TO ARRANGE PROVIDE PHYSICAL SPACE AND MAKE ARRANGEMENTS FOR PROGRESS MEETINGS.

#### **CONSTRUCTION SCHEDULE:**

- WITHIN 5 DAYS OF AWARD OF CONTRACT, THE CONTRACTOR IS TO PROVIDE TO THE CONSULTANT A PROJECT SCHEDULE, SHOWING MILESTONES DATES FOR THE FOLLOWING:
- SHOP DRAWING AND SAMPLES SUBMITTALS, DELIVERY SCHEDULE FOR KEY LANDSCAPE COMPONENTS OR FABRICATIONS ESSENTIAL TO THE PROGRESS OF THE WORK.

CLEAN COMPLETELY, FREE OF DEBRIS, ALL SURFACES SOFT LANDSCAPE, LANE, UNISTONE AREAS ADJACENT PERIMETER AREAS.

- STAKE LOCATION OF ALL PLANT MATERIAL IN RAIN GARDEN AREAS FOR CONSULTANT APPROVAL.
- GAIN ACCEPTANCE BY THE CONSULTANT, AT NO ADDITIONAL COST TO THE
- ACCEPTED SAMPLE INSTALLATIONS WILL BECOME THE STANDARD FOR THE PROJECT AND MAY BE INCORPORATED INTO THE WORK. ANY WORK WHICH DOES NOT MATCH THE ACCEPTED MOCK-UPS WILL BE REJECTED AND REPLACED TO MATCH ACCEPTED MOCK-UPS.

#### **REMOVAL /DEMOLITION NOTES:**

- CONTRACTOR IS RESPONSIBLE FOR VERIFYING ALL EXISTING CONDITIONS PRIOR TO BID.
- THE CONTRACTOR IS RESPONSIBLE FOR CHECKING REMOVAL /DEMOLITION STOCK FOR REUSABLE ITEMS PRIOR TO SUBMITTING A BID PRICE.
- ALL ITEMS IN REMOVAL /DEMOLITION STOCK WHICH ARE NOT TO BE REINSTALLED ARE TO BE BROUGHT TO THE ATTENTION OF THE OWNER. THE OWNER RESERVES THE RIGHT TO RETAIN REMOVED /DEMOLISHED ITEMS OR REQUEST THE CONTRACTOR TO DISPOSE OF THESE ITEMS.
- ALL ITEMS REMAINING TO APPEAR IN AS NEW CONDITION UPON COMPLETION OF CONSTRUCTION. MAKE GOOD ITEMS AS REQUIRED.
- CONTRACTOR TO REVIEW WITH THE CONSULTANT, ALL ITEMS THAT ARE UNCOVERED DURING DEMOLITION, THAT WERE NOT APPARENT PRIOR TO
- DEMOLITION, BEFORE REMOVING. CONTRACTOR TO ENSURE ALL LIFE-SAFTEY AND EMERGENCY SYSTEMS ARE IN WORKING ORDER AND LEFT INTACT AT THE END OF EACH DAY, DURING
- REMOVAL OF SURFACE CONDITIONS, WITHIN PROJECT BOUNDARY, TO SPECIFIED DEPTHS.
- CAREFUL REMOVAL AND STORAGE OF EXISTING SIGNAGE AT BOTTOM OF SLOPE FOR FUTURE REINSTALLATION.
- CONTRACTOR TO PROVIDE LUMP SUM PRICING FOR DEMOLITIONS WORKS.
- REMOVAL OF COLUMBARIUM TO BE DONE BY OTHERS, CONTRACTOR TO NOT INCLUDE REMOVAL OF COLUMBARIUM IN LUMP SUM.

#### GENERAL NOTES CONTINUED

#### **EROSION CONTROL**

ALL GRADING OPERATIONS SHALL BE CONDUCTED IN A MANNER TO MINIMIZE THE POTENTIAL FOR SOIL EROSION. SEDIMENT CONTROL PRACTICES MUST BE ESTABLISHED ON ALL DOWN-GRADIENT PERIMETERS BEFORE ANY UP-GRADIENT LAND DISTURBING ACTIVITIES BEGIN.

- ALL EXPOSED AREAS MUST BE STABILIZED AS SOON AS POSSIBLE TO LIMIT SOIL EROSION BUT IN NO CASE LATER THAN 14 DAYS AFTER CONSTRUCTION ACTIVITY IN THAT PORTION OF THE SITE HAS TEMPORARILY OR PERMANENTLY CEASED. TEMPORARY STOCKPILES WITHOUT SIGNIFICANT SILT, CLAY OR ORGANIC COMPONENTS (E.G. CLEAN AGGREGATE STOCKPILES, DEMOLITION UNISTONE STOCKPILES, SAND STOCKPILES) AND THE CONSTRUCTED BASE COMPONENTS OF UNISTONE PAVER AREAS, AND SIMILAR SURFACES ARE EXEMPT FROM THIS REQUIREMENT.
- INSPECT THE CONSTRUCTION SITE ONCE EVERY SEVEN DAYS DURING ACTIVE CONSTRUCTION AND WITHIN 24 HOURS AFTER A RAINFALL EVENT GREATER THAN 15 MM IN 24 HOURS.
- ALL EROSION CONTROL DEVICES MUST BE REPAIRED, REPLACED, OR SUPPLEMENTED WHEN THEY BECOME NON-FUNCTIONAL OR THE SEDIMENT REACHES 1/3 OF THE HEIGHT OF THE DEVICE. THESE REPAIRS MUST BE MADE WITHIN 24 HOURS OF DISCOVERY, OR AS SOON AS FIELD CONDITIONS ALLOW ACCESS.
- IF SEDIMENT ESCAPES THE CONSTRUCTION SITE, OFF-SITE ACCUMULATIONS OF SEDIMENT MUST BE REMOVED IN A MANNER AND AT A FREQUENCY SUFFICIENT TO MINIMIZE OFF-SITE IMPACTS.
- ALL SOILS TRACKED ONTO PAVEMENT SHALL BE REMOVED DAILY.
- UPON COMPLETION OF THE PROJECT AND STABILIZATION OF ALL EXCAVATED /GRADED AREAS, ALL TEMPORARY EROSION CONTROL FACILITIES SHALL BE REMOVED FROM THE SITE.
- CONTRACTOR TO PROVIDE LUMP SUM PRICING FOR EROSION AND SEDIMENT CONTROL.

- KNOWN UNDERGROUND AND SURFACE UTILITY LINES AND BURIED OBJECTS ARE INDICATED ON DRAWINGS. NO GUARANTEE IS GIVEN OF COMPLETENESS OR ACCURACY. MAKE GOOD AND PAY FOR DAMAGE TO EXISTING UTILITY LINES RESULTING FROM WORK.
- PREVENT DAMAGE TO ANY EXISTING ADJACENT TREES, LANDSCAPE, PAVEMENT, CONCRETE, GRANITE AND RELATED COLUMBARIA ELEMENTS. MAKE GOOD AND PAY FOR DAMAGE.
- EXCAVATED SOIL: SHALL BE REMOVED FROM THE SITE. BASE OF ALL SUBGRADE AREAS SHALL BE SHAPED SUITABLY AND TAMPED FIRM.
- CO-ORDINATE EXCAVATION OF RAIN GARDENS WITH CITY REPRESENTATIVE TO PROTECT ANY STRUCTURAL ROOTS OF ADJACENT TREES. EXCAVATE SOFT AREAS DETECTED DURING COMPACTION OF THE SUBGRADE
- AND REPLACE WITH LOW PLASTIC COHESIVE SOIL AND COMPACT TO 95% PROCTOR DENSITY.
- EXCAVATION TO BE PRICED IN CUBIC METERS.
  - TOPSOIL SUPPLY AND PLACEMENT TO BE PRICED AT A UNIT RATE IN CUBIC

#### SITE GRADING:

KNOWN UNDERGROUND AND SURFACE UTILITIES AND BURIED OBJECTS ARE INDICATED ON THE SITE PLAN. NO GUARANTEE TO COMPLETENESS OF THIS INFORMATION. ESTABLISH LOCATION OF UNDERGROUND UTILITIES PRIOR TO COMMENCING WORK.

PREVENT DAMAGE TO EXISTING ADJACENT CHARCOAL ROMAN-UNISTONE

- AREA AT CREST OF HILL, CURB, TREES, LANEWAY AND UTILITIES TO REMAIN. MAKE GOOD ANY DAMAGE. ALL ELEVATIONS AROUND THE PERIMETER OF THE PROJECT AREA SHALL BE
- FIELD VERIFIED. IF ELEVATIONS VARY SIGNIFICANTLY, NOTIFY THE CONSULTANT FOR FURTHER INSTRUCTIONS.
- GRADES SHOWN IN PAVED AREAS REPRESENT FINISH ELEVATION.
- FILL MATERIAL: PROTECT EXCAVATED AREA AND SUCH APPROVED MATERIAL FROM CONTAMINATION.
- ROUGH GRADE TO LEVELS, PROFILES, CONTOURS ALLOWING FOR SURFACE TREATMENT AS INDICATED.
- ROUGH GRADE TO THE INDICATED DEPTHS BELOW FINISH GRADES.
- SLOPE ROUGH GRADE AS INDICATED ON THE GRADING PLAN.
- COMPACT FILLED AND DISTURBED AREAS TO STANDARD PROCTOR DENSITY TO ASTM D698-78 AS FOLLOWS:
- 85% UNDER RAIN GARDEN LANDSCAPED AREAS 95% UNDER RAIN GARDEN TRAIL 98% UNDER NEW UNISTONE AREAS
- 10. GRANUAR PATHWAY TO BE PRICED AT A UNIT RATE IN SQUARE METERS.

#### RAIN GARDENS EXCAVATE RAIN GARDENS TO DEPTH INDICATED ON DRAWINGS.

- CO-ORDINATE WITH CITY REPRESENTATIVE TO PROTECT ANY STRUCTURAL ROOTS OF ADJACENT TREES.
- PLACE 20mm DIAMETER AQNGULAR DRAIN ROCK AT 400mm DEPTH, COVER WITH NON-WOVEN GEOTEXTILE FABRIC. ENSURE NON-WOVEN GETEXTILE
- PLACE CITY OF EDMONTON TYPE 7 TOPSOIL AT DEPTH INDICATED ON DRAWINGS.
- GRADE TOPSOIL TO A LOW POINT OF A MINUMUM OF 300mm FROM EDGE OF PATHWAY IN THE CENTER OF THE PLANTING BED AREA. THE INTENT IS TO CAPTURE RUNOFF ON RAINGARDENS.
- INSTALL PLANT MATERIAL ACCODING TO CITY OF EDMONTON DESIGN AND CONSTRUCTION STANDARDS FOR LANDSCAPING. REFER TO PLATING PLAN FOR PLANT MATERIAL AND LAYOUT.
- GRAVEL RESERVOIR TO BE PRICED AT A UNIT RATE IN SQUARE METERS.
- PLANTS TO BE PRICES AT A UNIT RATE PER SPECIES.

FABIC OVERLAPS MINIMUM 400mm.

- SCHEDULE PLACING OF RAIN GARDEN/BIORETENTION TOPSOIL AND FINISH GRADING TO PROFILE AS INDICATED ON DRAWINGS TO PERMIT PLANTING UNDER OPTIMUM CONDITIONS.
- THE GRADING CONTRACTOR SHALL RETAIN A SOILS ENGINEER TO VERIFY ALL FILL MATERIAL IS IN ACCORDANCE WITH THE SPECIFICATIONS.
- GRADES SHOWN IN PAVED AREAS REPRESENT FINISH ELEVATION.
- CARRY OUT SITE GRADING OPERATIONS SYSTEMATICALLY TO ALLOW FOR NATURAL SETTLEMENT OF SOFT LANDSCAPE AREAS AND MEET COMPACTION REFERENCED IN SPECIFICATIONS FOR ALL HARDSCAPE AREAS.
- GRADE SOIL IN SMOOTH TRANSITIONS, ELIMINATING UNEVEN AREAS. ENSURING POSITIVE DRAINAGE FROM CENTERLINE OF TRAIL SURFACE TO THE RAIN GARDEN /BIORETENTION AREAS OR OTHERWISE, AS INDICATED ON THE DRAWINGS.
- USE FROST-FREE MATERIALS OVER FROST-FREE GROUND CONDITIONS.
- MAINTAIN OPTIMUM MOISTURE CONTENTS TO ENABLE COMPACTED MATERIALS TO ATTAIN SPECIFIED DENSITY.

#### GENERAL NOTES CONTINUED:

- APPLY TOPSOIL PROFILE AS SHOWN ON DRAWINGS TO THE MINIMUM DEPTHS INDICATED FOR RAIN GARDEN /BIORETENTION AREAS.
- REHABILITATE FRINGE AREAS, AS NECESSARY, TO PRIOR CONSTRUCTION

#### CONDITION.

#### CONCRETE INSPECT ROUGH GRADES FOR SUITABILITY OF APPLICATION OF CONCRETE

- ENCASEMENT OF RAINWATER CHAMBER. KEEP ANY TRAFFIC OFF NEWLY CAST-IN-PLACE CONCRETE UNTIL CONCRETE
- HAS CURED, ALLOWING 28 DAYS.
- PROTECT ADJACENT SURFACES FROM DAMAGE. MAKE GOOD ANY DAMAGE
- GRANULAR BASE: AS INDICATED ON DRAWINGS.
- CEMENT: SULPHATE RESISTANT SYMBOL 50 PORTLAND TYPE.
- FINE AND COURSE AGGREGATES: STANDARD CONCRETE TYPE, 20 MM
- WELDED STEEL WIRE FABRIC: PLAIN TYPE, PLAIN FINISH.
- TIE WIRE: MINIMUM 16-GAUGE ANNEALED TYPE.
- FORMWORK: WELL MATCHED, TIGHT FITTING, AND ADEQUATELY STIFFENED TO SUPPORT WEIGHT OF CONCRETE WITHOUT DEFLECTION DETRIMENTAL TO TOLERANCES AND APPEARANCE OF CONCRETE.
- CONCRETE CURING COMPOUND: CHLORINATED RUBBER TYPE, CLEAR
- CONCRETE: MIX AND PROPORTION TO PRODUCE MINIMUM 25 MPA CONCRETE AT 28-DAY WITH A MAXIMUM SLUMP OF 75 MM PLUS OR MINUS 25 MM, AND 4 TO 7 PER CENT AIR ENTRAINMENTS.
- 12. CONTROL JOINT: TOOLED JOINT AT 1.5 M O.C. MAXIMUM.

#### BASALT SLAB BENCHES AND STEP-ASIDES SLAB BENCHES TO BE CASCADES STONEWORKS BASLAT COLUMN BENCH

- WITH POLISHED TOP. 1500mm IN LENGTH. CONTRACTOR TO CONSULT WITH OWNER FOR SELECTION OF EACH BASALT
- DIMENSIONS VARY, AS INDICATED ON DRAWINGS.

#### PRODUCT SPECIFICATIONS

COLUMN.

- 31 32 19.13 GEOGRID SOIL STABILIZATION GENERAL
- 1.01 RELATED SECTIONS
- 32 13 00 RIGID PAVING
- MEASUREMENT AND PAYMENT MEASURE GEOGRID IN SQUARE METERS OF SURFACE COVERED BY MATERIAL. NO ALLOWANCE WILL BE MADE FOR SEAMS AND OVERLAP.

#### 1.03 REFERENCES

- ASTM D 1248-[05], STANDARD SPECIFICATION FOR POLYETHYLENE PLASTICS EXTRUSION MATERIALS FOR WIRE AND CABLE
- ASTM D 4101-[10], STANDARD SPECIFICATION FOR POLYPROPYLENE INJECTION AND EXTRUSION MATERIALS. CONTENT IN POLYETHYLENE COMPOUNDS BY THE MUFFLE-FURNACE TECHNIQUE. ASTM D 5262-[07], STANDARD TEST METHOD FOR EVALUATING THE UNCONFINED TENSION CREEP BEHAVIOUR OF
- GEOSYNTHETICS. ASTM D 6637-[10], STANDARD TEST METHOD FOR DETERMINING TENSILE PROPERTIES OF GEOGRIDS BY THE SINGLE OR MULTI-RIB

#### LEED CANADA-NC VERSION 1.0-[2004], LEED (LEADERSHIP IN ENERGY AND ENVIRONMENTAL DESIGN): GREEN BUILDING RATING SYSTEM REFERENCE PACKAGE FOR NEW CONSTRUCTION AND MAJOR

RENOVATIONS (INCLUDING ADDENDUM [2007]). DREXEL UNIVERSITY - GEOSYNTHETIC RESEARCH INSTITUTE (GRI) GRI GG2-[87(R2005)], GEOGRID JUNCTION STRENGTH

#### U.S. ENVIRONMENTAL PROTECTION AGENCY (EPA) / OFFICE OF WATER

TENSILE METHOD

EPA 832/R-92-005. STORM WATER MANAGEMENT FOR CONSTRUCTION ACTIVITIES: DEVELOPING POLLUTION PREVENTION PLANS AND BEST MANAGEMENT PRACTICES.

CANADA GREEN BUILDING COUNCIL (CAGBC)

#### 1.04 SUBMITTALS SAMPLES:

SUBMIT SAMPLES PRIOR TO BEGINNING WORK. SAMPLE TO BE ONE 3M LENGTH FROM FULL ROLL WIDTH OF GEOGRID MATERIAL.

DURING DELIVERY AND STORAGE, PROTECT GEOGRIDS FROM DIRECT

#### SUBMIT COPIES OF MILL TEST DATA AND CERTIFICATE PRIOR TO START OF WORK.

- 1.05 DELIVERY AND STORAGE DELIVER, STORE AND HANDLE MATERIALS IN ACCORDANCE WITH MANUFACTURER'S WRITTEN INSTRUCTIONS.

#### SUNLIGHT, ULTRAVIOLET RAYS, EXCESSIVE HEAT, MUD, DIRT, DUST, DEBRIS AND RODENTS.

#### PRODUCTS 2.01 MATERIAL

#### **NILEX GEOGRID: TRIAX TX130S GEOGRID**

LAYERS.

- EXECUTION
- TEMPORARY EROSION AND SEDIMENT CONTROL PROVIDE TEMPORARY EROSION AND SEDIMENTATION CONTROL MEASURES TO PREVENT SOIL EROSION AND DISCHARGE OF SOIL-BEARING WATER RUNOFF OR AIRBORNE DUST TO ADJACENT
- DESIGN STANDARDS. INSPECT, REPAIR, AND MAINTAIN EROSION AND SEDIMENTATION CONTROL MEASURES DURING CONSTRUCTION UNTIL PERMANENT VEGETATION HAS BEEN ESTABLISHED.

#### AND STABILIZE AREAS DISTURBED DURING REMOVAL. 3.02 INSTALLATION PLACE GEOGRID MATERIAL BY UNROLLING ONTO GRADED

POSITION IN ACCORDANCE WITH MANUFACTURER'S WRITTEN RECOMMENDATIONS. PLACE GEOGRID ON SLOPING SURFACES IN ONE CONTINUOUS

SURFACE IN MANNER AND LOCATIONS INDICATED AND RETAIN IN

PROPERTIES AND WALKWAYS, ACCORDING TO CITY OF EDMONTON

REMOVE EROSION AND SEDIMENTATION CONTROLS AND RESTORE

OVERLAP EACH SUCCESSIVE STRIP OF GEOGRID 500MM OVER PREVIOUSLY LAID STRIP.

LENGTH FROM TOE OF SLOPE TO UPPER EXTENT OF GEOGRID.

MANUFACTURER. PROTECT GEOGRID FROM DISPLACEMENT, DAMAGE OR DETERIORATION BEFORE AND DURING PLACEMENT OF OVERLAY SOIL

JOIN SUCCESSIVE STRIPS OF GEOGRID AS RECOMMENDED BY

#### GENERAL NOTES CONTINUED

SECTION 32 13 00.

1.02 31 32 19.13 GEOGRID SOIL STABILIZATION

UNIT PAVER TEST DATA

RECYCLING FACILITIES.

REPRESENTATIVE.

RECYCLING FACILITY

AREA FOR RECYCLING.

LANDSCAPE ARCHITECT.

COMPACT TO 95% SPD.

SUBMIT A SAMPLE PER TYPE OF UNIT PAVER

QUARRY AS APPROVED BY CITY REPRESENTATIVE.

LANDFILL TO LOCAL QUARRY AS APPROVED BY CITY

SHOP DRAWINGS

1.03 MEASUREMENT PROCEDURES:

3.04 PROTECTION

**32 13 00 RIGID PAVING** 

1.04 SUBMITTALS

1.01 RELATED SECTIONS

1.05 WASTE MANAGEMENT

PRODUCTS

EXECUTION

3.03 GEOGRID

3.04 GRAVEL BASE

3.06 BEDDING SAND

3.07 SURFACE COURSE

PROJECT AREA.

COMPLETION OF COMPACTION.

2.01 MATERIALS

**END OF SECTION** 

1.1 GENERAL

APPROVAL OF CITY REPRESENTATIVE.

RUBBISH, TOOLS AND EQUIPMENT.

- .6 AFTER INSTALLATION, COVER WITH OVERLAY LAYER WITHIN 10
- DAYS OF PLACEMENT.

.8 PLACE AND COMPACT SOIL LAYERS IN ACCORDANCE WITH

[01 74 11 - CLEANING]. LEAVE WORK AREA CLEAN AT END OF EACH

FINAL CLEANING: UPON COMPLETION REMOVE SURPLUS MATERIALS

UNIT PAVING WILL BE MEASURED FOR PAYMENT IN SQUARE METERS.

REMOVE AND DISPOSE ALL PACKAGING MATERIALS AT APPROPRIATE

DIVERT ALL UNUSED CONCRETE MATERIAL FROM LANDFILL TO LOCAL

FOLD UP ALL METAL BANDING, FLATTEN AND PLACE IN DESIGNAT5ED

**UNIT PAVER**: CONTRACTOR TO FIND A PAVER MATCHING EXISTING

JOINT SAND: ROMPOX D2000-COMPONENT EPOXY RESIN JOINTING

PROTECT EXITING TREES, GRAVE SITES, GRAVE MARKERS AND

ENSURE THAT SUBGRADE IS FREE OF LARGE ROCKS AND ROOTS

INSTALL GEOGRID AS PER MANUFACTURER'S SPECIFICATIONS.

UNIFORMLY SPREAD AND COMPACT GRAVEL IN 100MM LIFTS.

ENSURE CONFORMITY OF GRADES WITH FINISH SURFACE.

PLACE AND SPREAD BEDDING SAND TO 30MM DEPTH

DO NOT USE JOINT SAND FOR BEDDING SAND.

INSTALL EDGING TRUE TO GRADE, IN LOCATION INDICATED ON

EDGING TO CONFORM WITH CITY OF EDMONTON LANDSCAPE DESIGN

UNIT PAVER TO MATCH EXISTING LAYOUT CONDITIONS ADJACENT TO

PASS MECHANICAL PLATE VIBRATOR OVER UNIT PAVING TO ACHIEVE

AT COMPLETION OF EACH WORK DAY, ENSURE WORK WITHIN 1M OF

LAYING FACE IS LEFT FULLY COMPACTED WITH SAND FILLED JOINTS.

**END OF SECTION** 

FILL SPACES BETWEEN PAVERS BY SWEEPING IN JOINT SAND.

COMPACTION OF SAND IN JOINTS. ENSURE JOINTS ARE FULL AT

SURFACE OF FINISHED PAVEMENT: FREE FROM DEPRESSIONS

EXCEEDING 3MM AS MEASURED WITH A 3M STRAIGHT EDGE.

SWEEP SURFACE CLEAN AND CHECK FOR CONFORMANCE TO

COLUMBARIA TO REMAIN. MAKE GOOD ANY DAMAGE.

PAVERS ON SITE AND SUBMIT A SAMPLE FOR APPROVAL BY

**CRUSHED GRAVEL BASE**: AS INDICATED ON DRAWINGS.

**BEDDING SAND**: AS INDICATED ON DRAWINGS.

LINEAR PAVER: AS INDICATED ON DRAWINGS.

**EDGING:** AS INDICATED ON DRAWINGS.

BASE MINIMUM THICKNESS OF 300MM

COMPACT GRAVEL BASE TO 98% SPD.

STANDARDS, MOST CURRENT EDITIONS.

SEPARATE WASTE MATERIALS FOR REUSE AND RECYCLING.

DIVERT ALL UNUSED AGGREGATE MATERIALS MATERIAL FROM

DIVERT ALL UNUSED GEOTEXTILES FROM LANDFILL TO PLASTIC

PROGRESS CLEANING: CLEAN IN ACCORDANCE WITH SECTION

VEHICULAR TRAFFIC NOT PERMITTED DIRECTLY ON GEOGRID.

- REPLACE DAMAGED OR DETERIORATED GEOGRID TO 340 12 Avenue SW
  - Calgary, AB Canada T2R 1L5 T: 403.245.3089
  - www.lemaytoker.com Lemay + Toker is a trade name owned and used by Toker + Associates Architecture Industrial Design Ltd.
    - **CONSULTANTS**

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#### PROJECT TITLE **MT PLEASANT UNISTONE &**

**MEMORIAL PLAZA** MOUNT PLEASANT CEMETERY

5420 106 ST N.W.

EDMONTON, AB

# T6H 2S9 ISSUE: 2

2020-03-19 ISSUED FOR TENDER

1:100

CITYE-18-01

2019-11-12 ISSUED FOR CLIENT

REVIEW DESIGN No. Date Description

SCALE:

MT/MG DRAWN BY:

DRAWING CONTENTS

CHECKED BY/QA:

PROJECT NO:

**GENERAL NOTES** 

SHEET NUMBER

	Materia										
Material Type	Tag	Quantity	Location	Manufacturer	Finish	Pattern	Colour	Style	Size	Installation Pattern	Comments
Landscape Composition Geogrid	GG1		Rain Garden and Trail Substrate	Syntec, Tenax, Terrafix, or Approved Substitute		N/A	N/A	N/A	Roll		Contractor to refer to geotechnical report and to provide shop drawings for selected materials.
_andscape Geotextile	LG1		Rain Garden and Trail Substrate	Nilex 4551, Layfield LP6, or Approved Alternate		Overlapping, continuous.	N/A	Non-Woven Geotextile	Roll	Overlapping per manufacturer's installation instructions.	Prepare installation area by removing topsoil, weeds, vegetation, stones, or sharp objects that may puncture the geotextile, prior to installation.
New Fill	NF1		Rain Garden and Trail Substrate				N/A	N/A	N/A	Uncompacted or Compacted	
_andscape Elements											
Commemorative Memorial Pillow Monument	CP1	5	Rain Gardens	3		N/A		N/A	As drawn on detail sheets.	Install as shown on drawings.	Refer to details.
Small Stone	ST1	8	Rain Gardens		Natural sides, Flat, polished top	N/A	Natural, Grey Basalt	N/A	Approx. 350 x 600.	Install as shown on drawings.	Install as shown on site plan. Refer to details page for sub-grade preparation. Install minimum 1/3 of total depth below finished grade. Front edge of stone to meet front edges of adjacent stones, as shown on drawings. Install and settle all stone element
Medium Stone	ST2	5	Rain Gardens		Natural sides, Flat, polished top	N/A	Natural, Grey Basalt	N/A	Approx. 650 x 800	Install as shown on drawings.	Install as shown on site plan. Refer to details page for sub-grade preparation. Install minimum 1/3 of total depth below finished grade. Front edge of stone to meet front edges of adjacent stones, as shown on drawings. Install and settle all stone elements prior to installation of seed, sod, or landscape planting.
Stone Bench	ST3	3	Rain Gardens		Natural sides, Flat, polished top	N/A	Natural, Grey Basalt	N/A	Approx. 1650 x 465	Install as shown on drawings.	Install as shown on site plan. Refer to details page for sub-grade preparation. Install minimum 1/3 of total depth below finished grade. Front edge of stone to meet front edges of adjacent stones, as shown on drawings. Install and settle all stone element
Obelisk	ST4	2	New Columbaria Plaza		Natural sides and top	N/A	Natural, Grey Basalt	Per details sheets,	As per detail.	Install as shown on drawings.	Refer to detail.
Rain Garden Composition											
Growing Medium	GM1	± 75 sq. m. Refer to L-106 for soil depths.	Rain Gardens	s N/A	N/A	N/A	N/A	N/A	N/A		Provide soil adhering to the City of Edmonton Topsoil Type 7 - Low Impact Development requirements. Refer to Table 2 in Cty of Edmonton Design and Construction Standards Landscape (most recent version).
Gravel Reservoir	GR1	± 75 sq. m. Refer to L-104 - L-106 for sub-base locations and depths.			Per manufacturer instructions.	N/A	N/A	N/A	N/A	20mm washed angular drain rock	Gravel drainage Reservoir at the base of rain gardens, and for use in French Drain system.
Weeping Tile	WT1	•	Rain Gardens	3	N/A		N/A	N/A	150mm Min.	Install as shown on drawings.	Refer to details page for installation and requirements.
Trail Composition											
Trench Drain	DR1	2	Ends of trail. Refer to Site Construction Plan	ACO Systems Ltd. or Approved Alternate	Grate Type 8800	"Wave Iron" grate pattern.	Iron.	K300 12" Drainlok Grate	300 W x 300 D minimum. Length as described on Site Construction plan.	Linear as shown.	Install per manufacturer instructions.
Compacted Gravel Crush Base	GC1		Trail Substrate	е		N/A	N/A		20mm minus road crush gravel	Min. 100mm depth of 20mm minus road crush gravel, compacted to 97% S.P.D.	
Compacted Gravel Crush Sub-Base	GC2		Trail Substrate	e		N/A	N/A		40mm minus road crush gravel	Min. 100mm depth of 40mm minus road crush gravel, compacted to 97% S.P.D.	
	LE1		Refer to Drawings	Surefoot or Approved Alternate	N/A	Continuous	Black	Plastic Edging	Ensure edging is appropriately sized to restrain paver.	Continuous. Secure with min. 10" spiral landscape spikes.	Continuous landscape edging
Landscape Edging		± 32 sq. m.	Trail					N/A	6mm minus, min. 75mm depth.		Refer to drawing LA303 - 'Granular Cross Section (Typ.)" in City of Edmonton Design and Construction Landscaping guide (most Recent edition)
	TR1										
Compact Granular Crush Pathway	TR1										
Compact Granular Crush Pathway  Unistone Paving  RomPox D2000-Component Epoxy Resin	TR1		New Unistone Paving areas		Per manufacturer instructions.	N/A	Charcoal grey	N/A	N/A	Joints between pavers	Provide colour sample to consultant prior to installation. Match existing unistone paving mortar
Landscape Edging  Compact Granular Crush Pathway  Unistone Paving  RomPox D2000-Component Epoxy Resin Jointing Mortar  Unistone Paver		± 60 sq. m.		•	Per manufacturer instructions.  Match Existing Unistone Pavers	N/A  Match Existing Unistone Paver 'fan' pattern.	Match Existing		N/A  Match existing paver dimensions	<u>'</u>	Provide colour sample to consultant prior to installation. Match existing unistone paving mortar Roman Paver in "fan" pattern, to match existing unistone pavers. Provide (3) three samples of Unistone paver, to be approved by consultant prior to installation.

### GENERAL DRAFTING SYMBOLS

OLIVLIVAL DIVALTINO OTIVIDOLO						
DRAWING TITLE	(1)	View Name  ADDITIONAL TEXT View Scale				
ELEVATION MARKERS	S A1					
SECTION MARKER		Ref A101				
CALLOUT / DETAIL VII	EW	1 A101	Ref			
NORTH ARROW	N	LANDSCAPE ELEMENT TAG	⟨XX1⟩			
GRID HEAD	0	LEVEL HEAD	Name Elevation			
REVISION TAG	1	KEYNOTE TAG	x			

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#### PROJECT TITLE

### MT PLEASANT **UNISTONE & MEMORIAL PLAZA**

MOUNT PLEASANT CEMETERY 5420 106 ST N.W. EDMONTON, AB T6H 2S9

ISSUE: 2 2 2020-03-19 ISSUED FOR TENDER
1 2019-11-12 ISSUED FOR CLIENT REVIEW DESIGN

1:100

SCALE:

MG/MT DRAWN BY:


CHECKED BY/QA: TK

PROJECT NO: CITYE-18-01

DRAWING CONTENTS

### **SPECIFICATIONS** + FINISHES

SHEET NUMBER

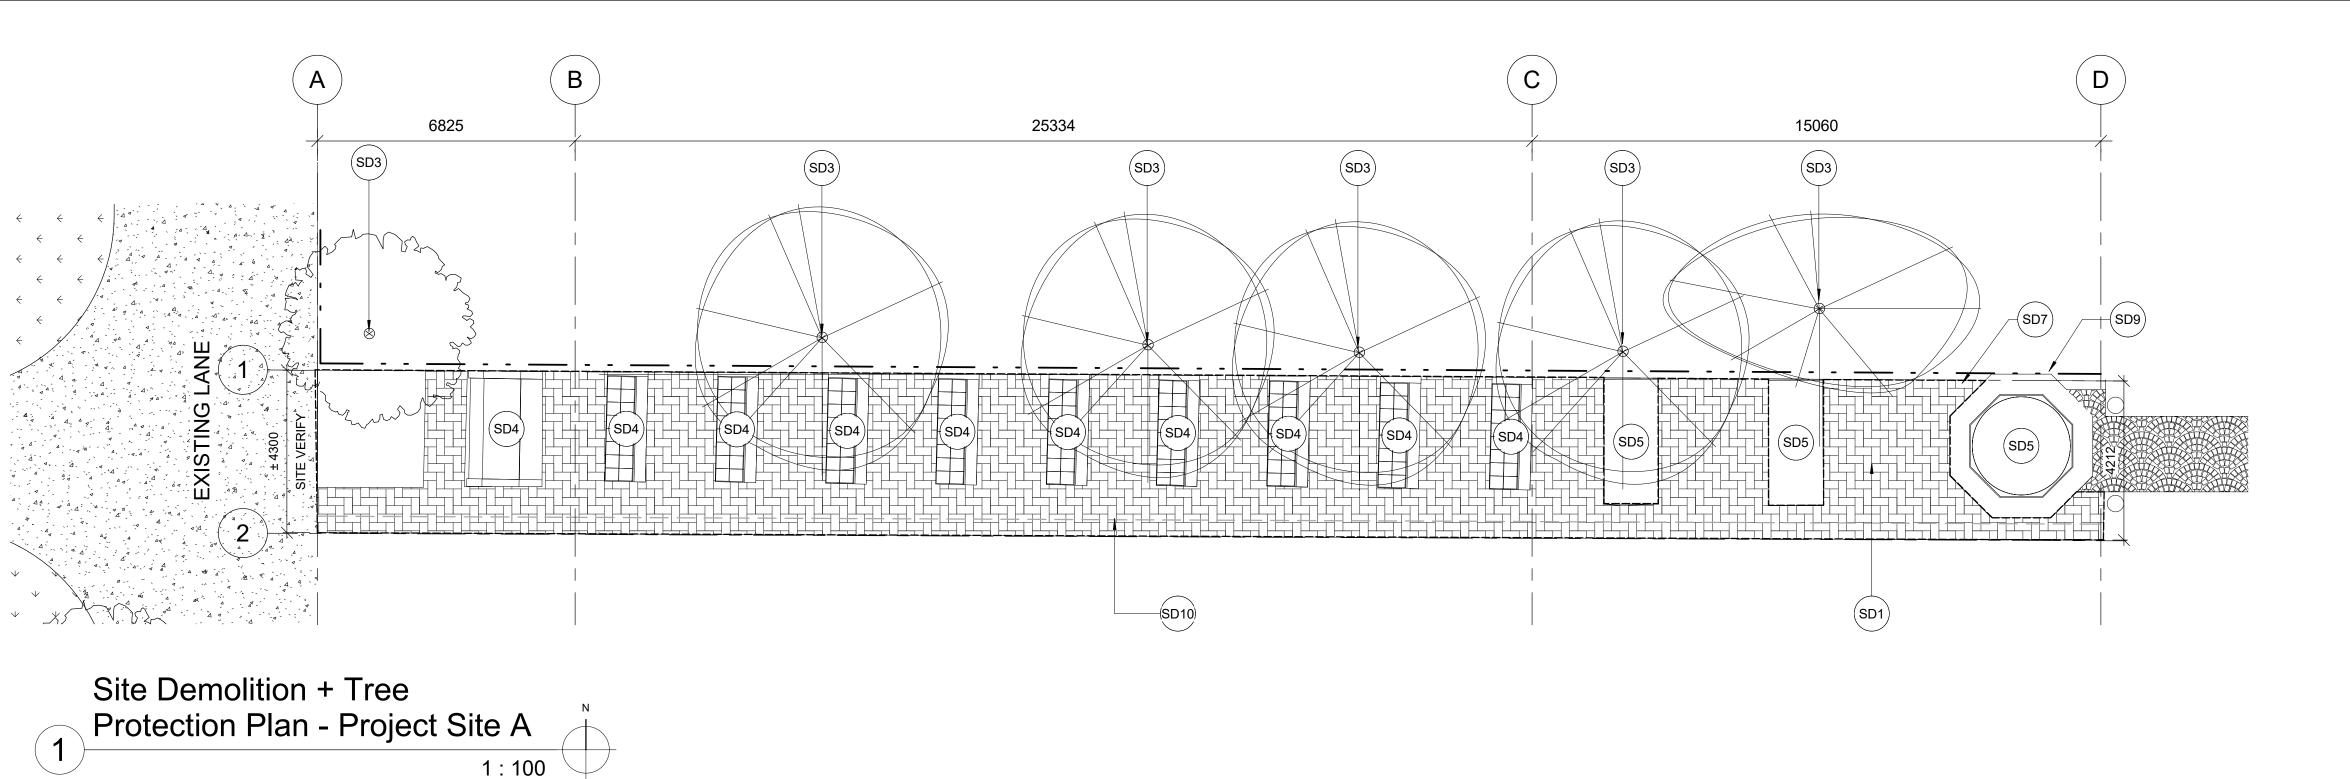

# C/L OF TREE TREE/VEGETATION TO BE PROTECTED TREE PROTECTION FENCE WARNING SIGN

Tree Protection Detail 3 I re 1:100

#### SITE DEMOLITION GENERAL NOTES:

OF DEMOLITION WORKS.

- SITE VERIFY ALL MEASUREMENTS PRIOR TO COMMENCEMENT OF DEMOLITION OR CONSTRUCTION ACTIVITIES.
- CONTRACTOR TO PATCH & MAKE GOOD TO RECEIVE NEW FINISHES ANY EXISTING PATHWAY OR LANDSCAPE ELEMENTS AFFECTED AFTER COMPLETION
- PROTECT ALL TREES AND EXISTING COLUMBARIA TO REMAIN IN PLACE DURING DEMOLITION ACTIVITIES.
- PROTECT TREES AND TREE ROOTS FROM DAMAGE DURING EXCAVATION ACTIVITIES.

## SITE DEMOLITION LEGEND

DEMOLISH EXISTING HERRINGBONE UNISTONE PAVING

EXISTING "FAN" PATTERN UNISTONE PAVING TO REMAIN

LINE OF TREE PROTECTION HOARDING

LINE OF EXCAVATION FOR WALKWAY

EXISTING IRRIGATION LINE

### SITE DEMOLITION KEYNOTES

- DEMOLISH EXISTING HERRINGBONE PATTERN UNISTONE PAVING. CAREFULLY EXPOSE EXISTING TREE ROOTS AND IRRIGATION LINE USING HAND TOOLS PRIOR TO MACHINE EXCAVATION, TO AVOID DAMAGE TO EXISTING TREES AND IRRIGATION LINE.
- PROTECT EXISTING TREES FROM DAMAGE DURING DEMOLITION AND CONSTRUCTION ACTIVITIES. REFER TO TREE PROTECTION DETAIL.
- REMOVALE OF COLUMBARIUM BY OTHERS.
- PROTECT EXISTING COLUMBARIUM DURING DEMOLITION, EXCAVATION, AND CONSTRUCTION ACTIVITIES.
- DEMOLISH EXISTING RAILING AND CURB.
- EXCAVATE TO END OF EXISTING UNISTONE PATHWAY AND LANDSCAPE
- EXCAVATE EXISTING LANDSCAPED AREA.
- LINE OF TREE PROTECTION HOARDING. DO NOT DISTURB SURROUNDING
- GRAVES OR EXISTING LANDSCAPE ELEMENTS ADJACENT TO PROJECT AREA. APPROXIMATE LOCATION OF EXISTING IRRIGATION LINE. CONTRACTOR TO
- FIELD VERIFY.


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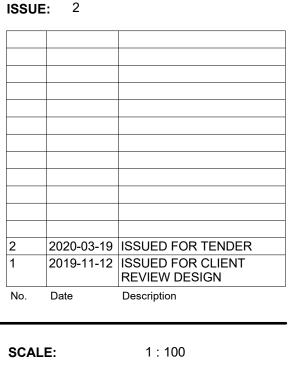
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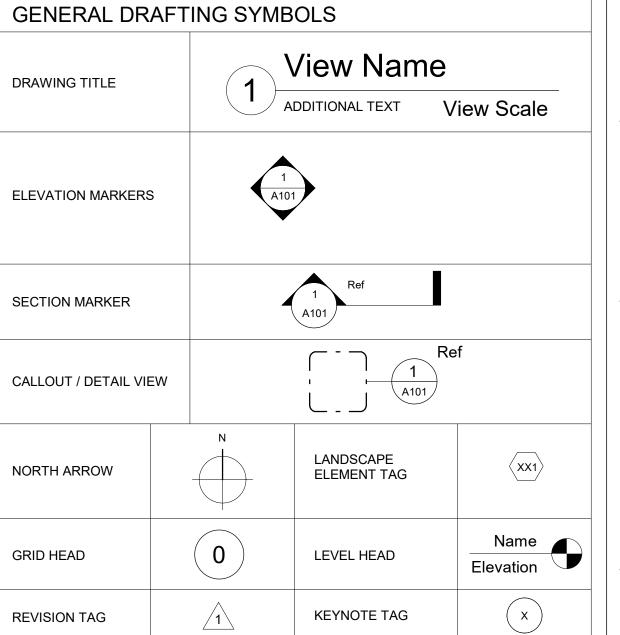
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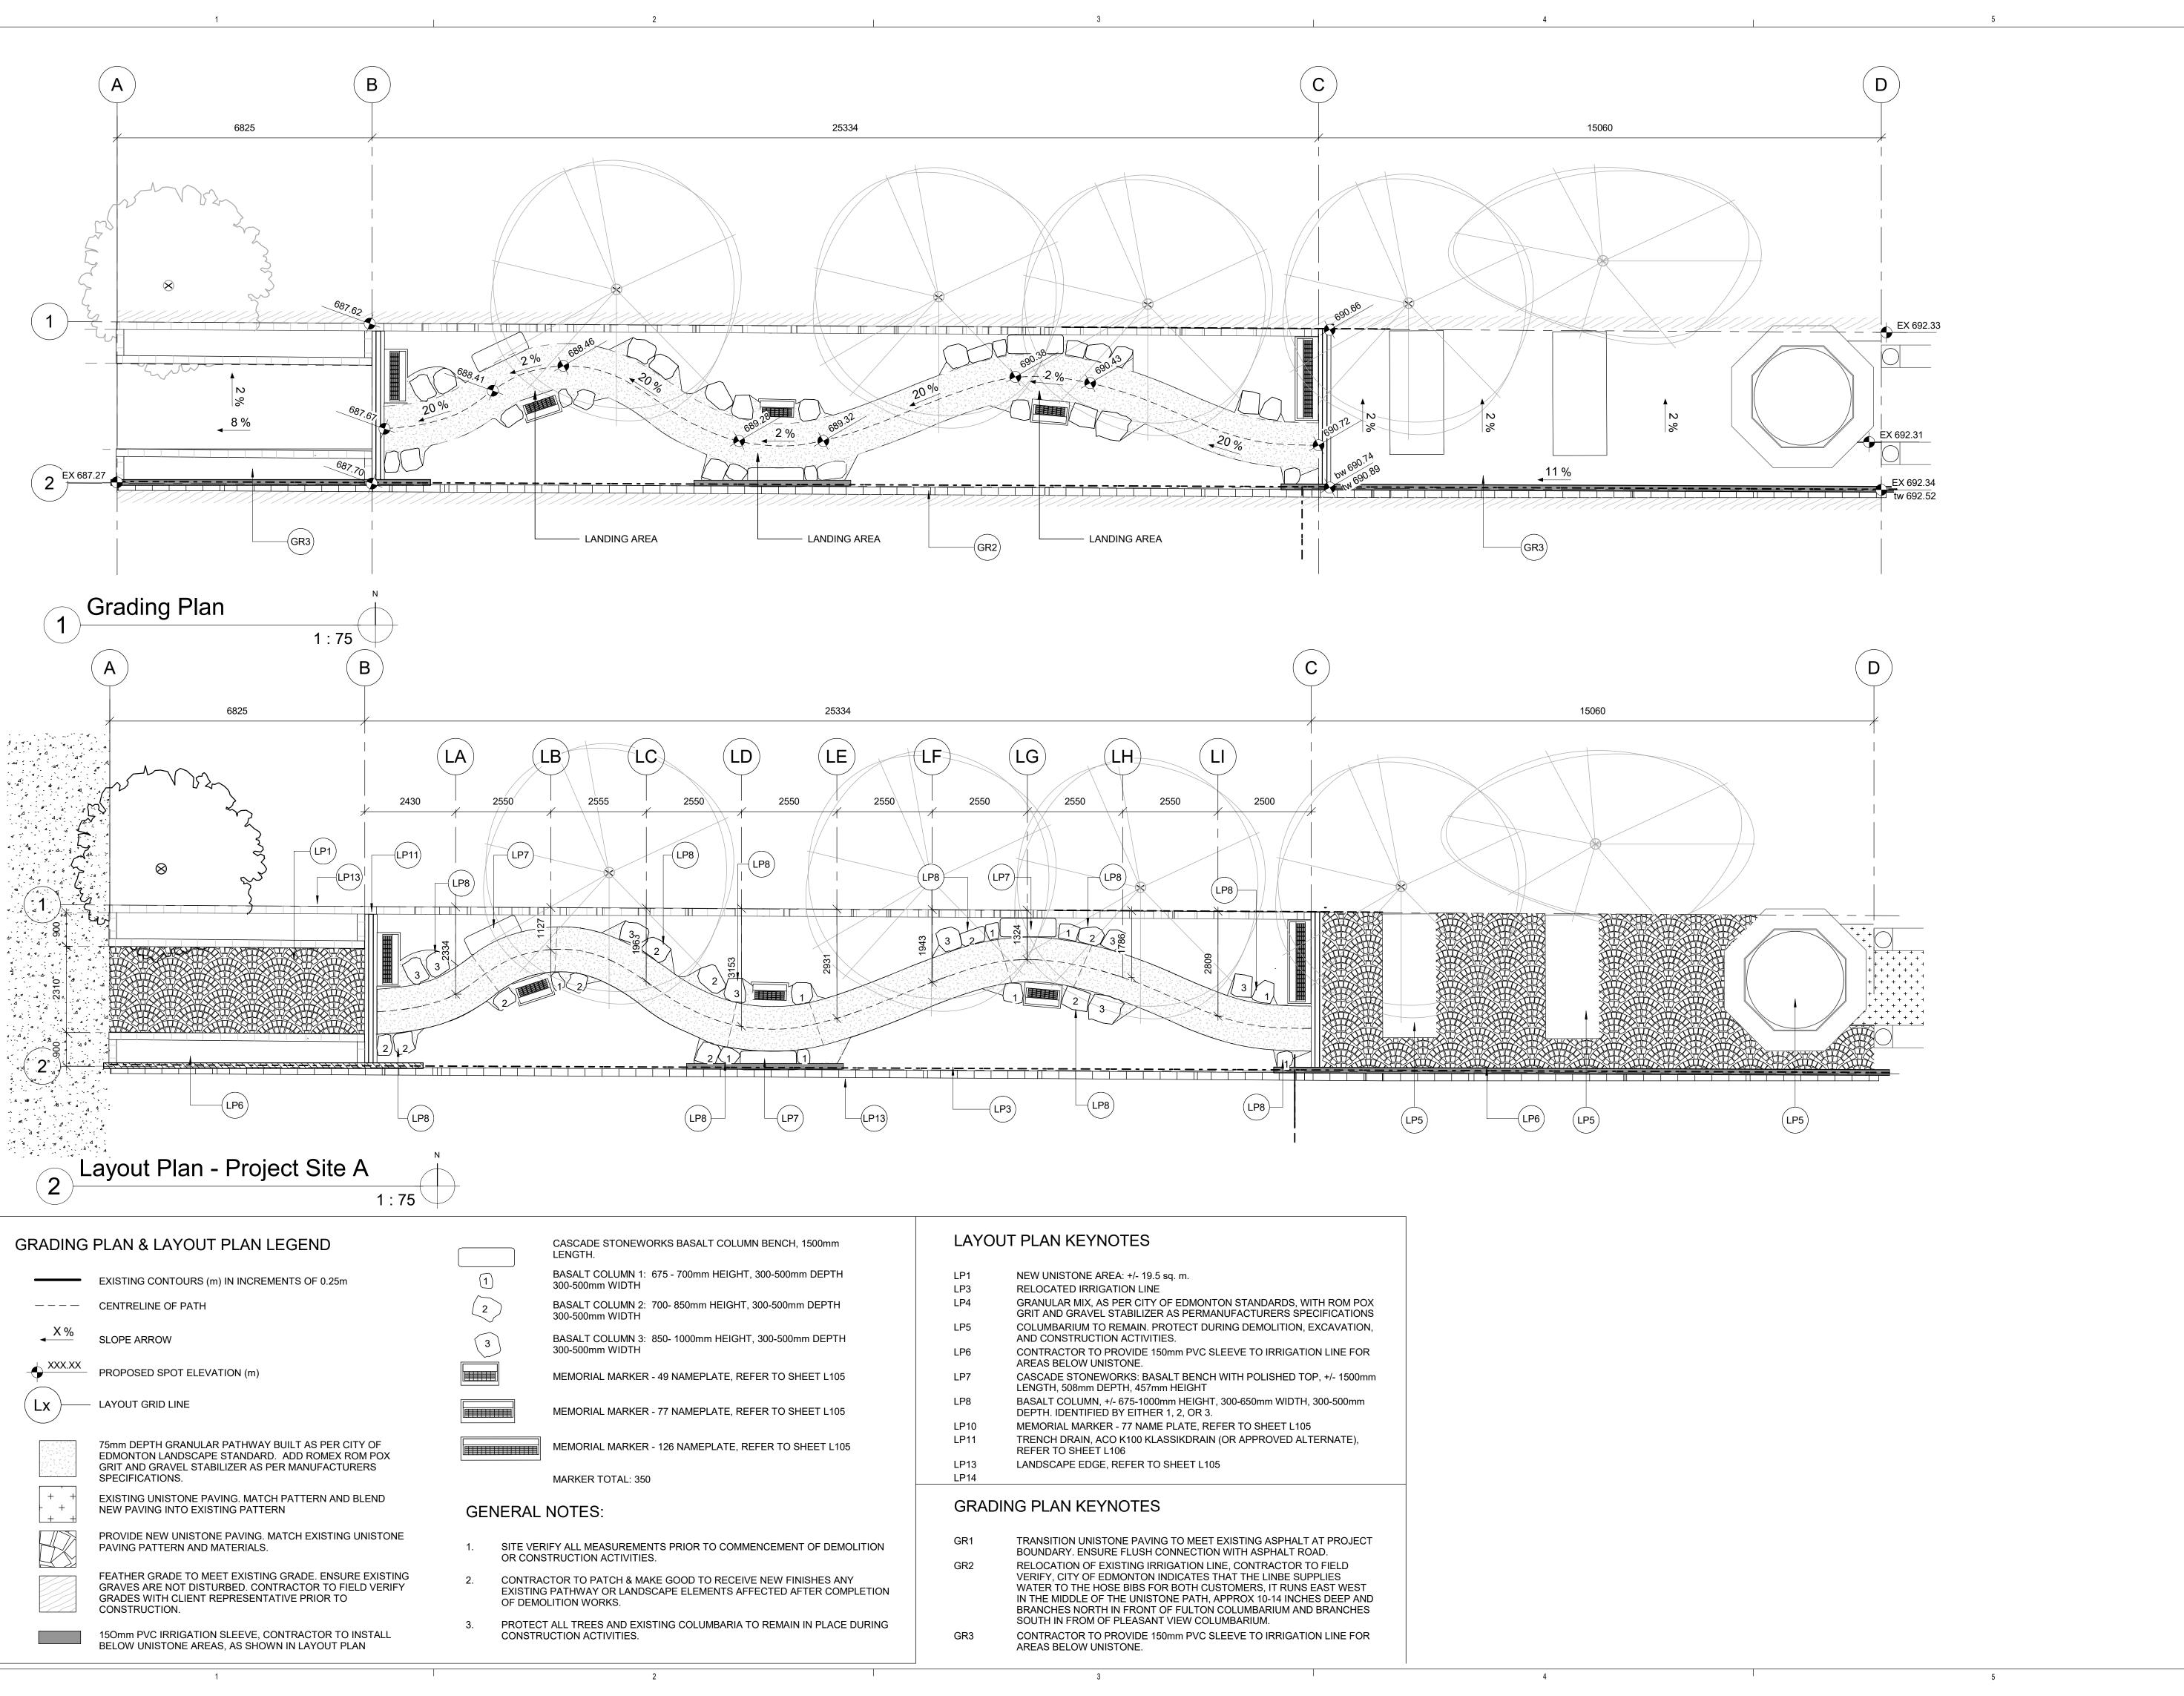
DRAWING CONTENTS

SITE DEMO, TREE PROTECTION-PROJECT SITE A

CITYE-18-01

SHEET NUMBER



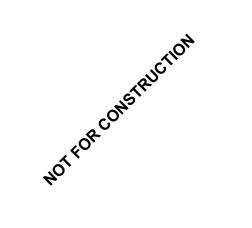

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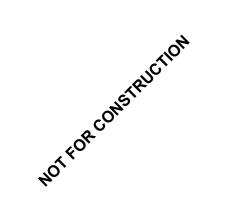
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PROJECT TITLE

### MT PLEASANT UNISTONE & MEMORIAL PLAZA

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2 2020-03-19 ISSUED FOR TENDER
1 2019-11-12 ISSUED FOR CLIENT REVIEW DESIGN

MG/MT

SCALE: As indicated

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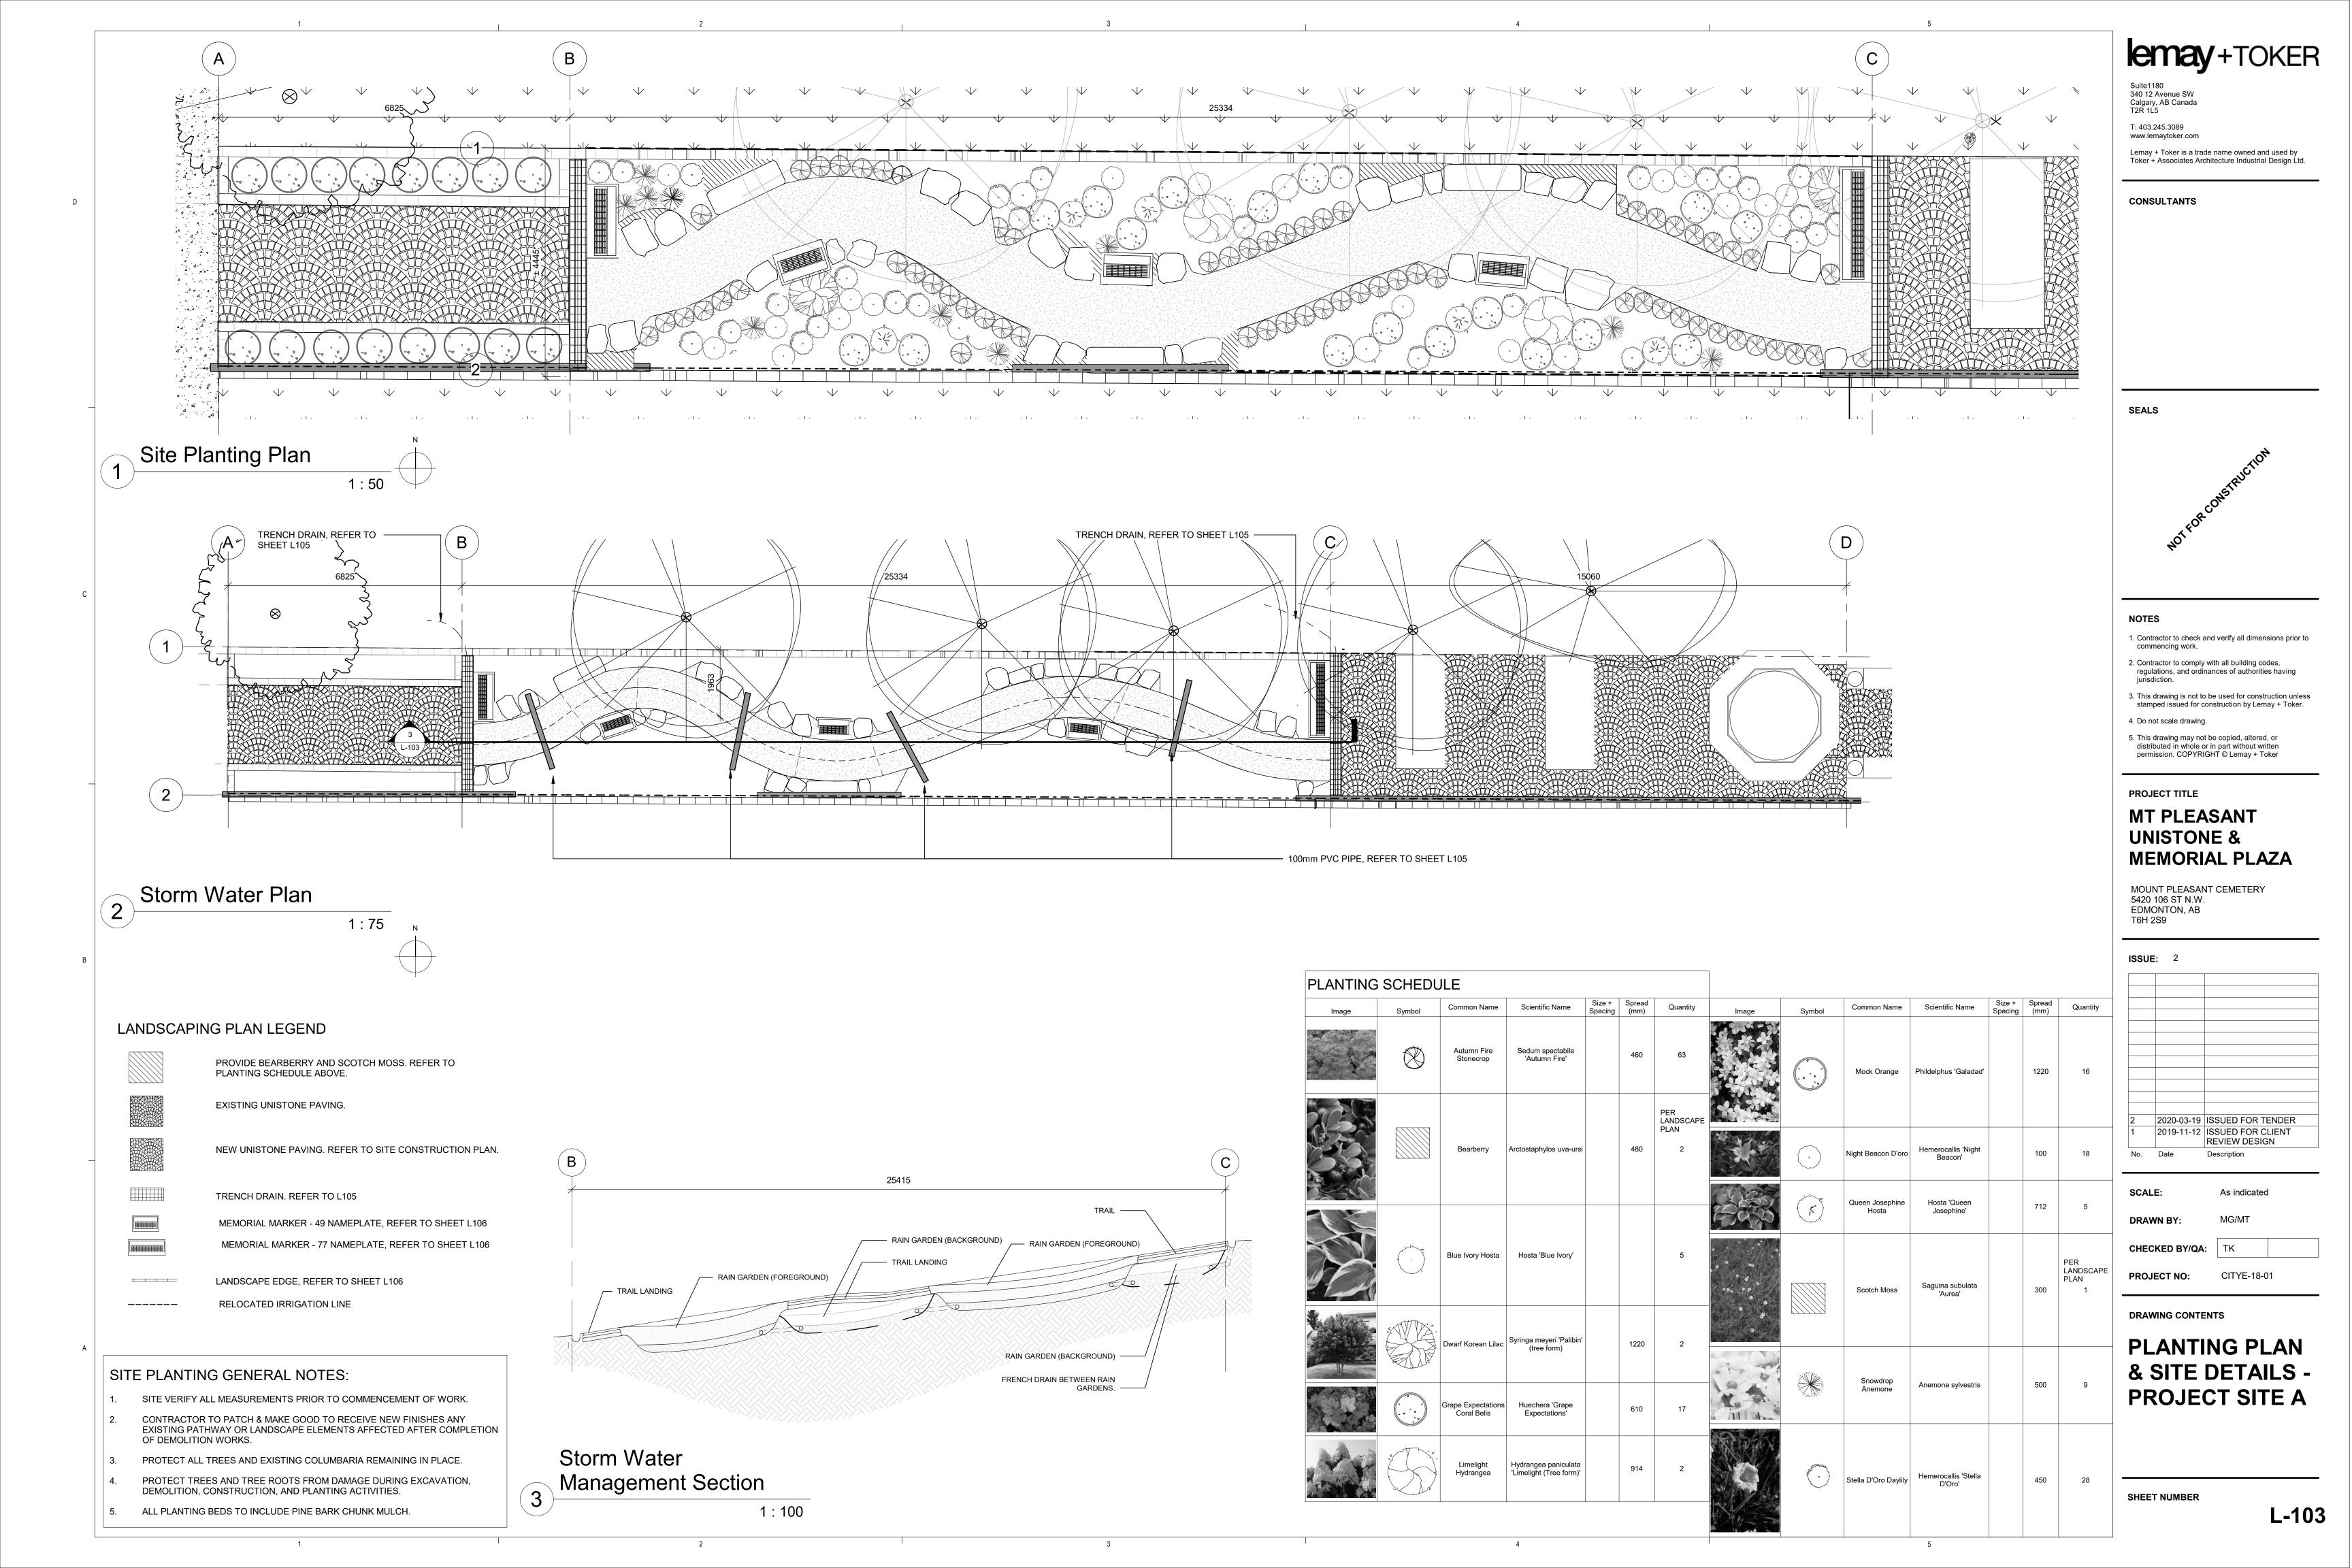
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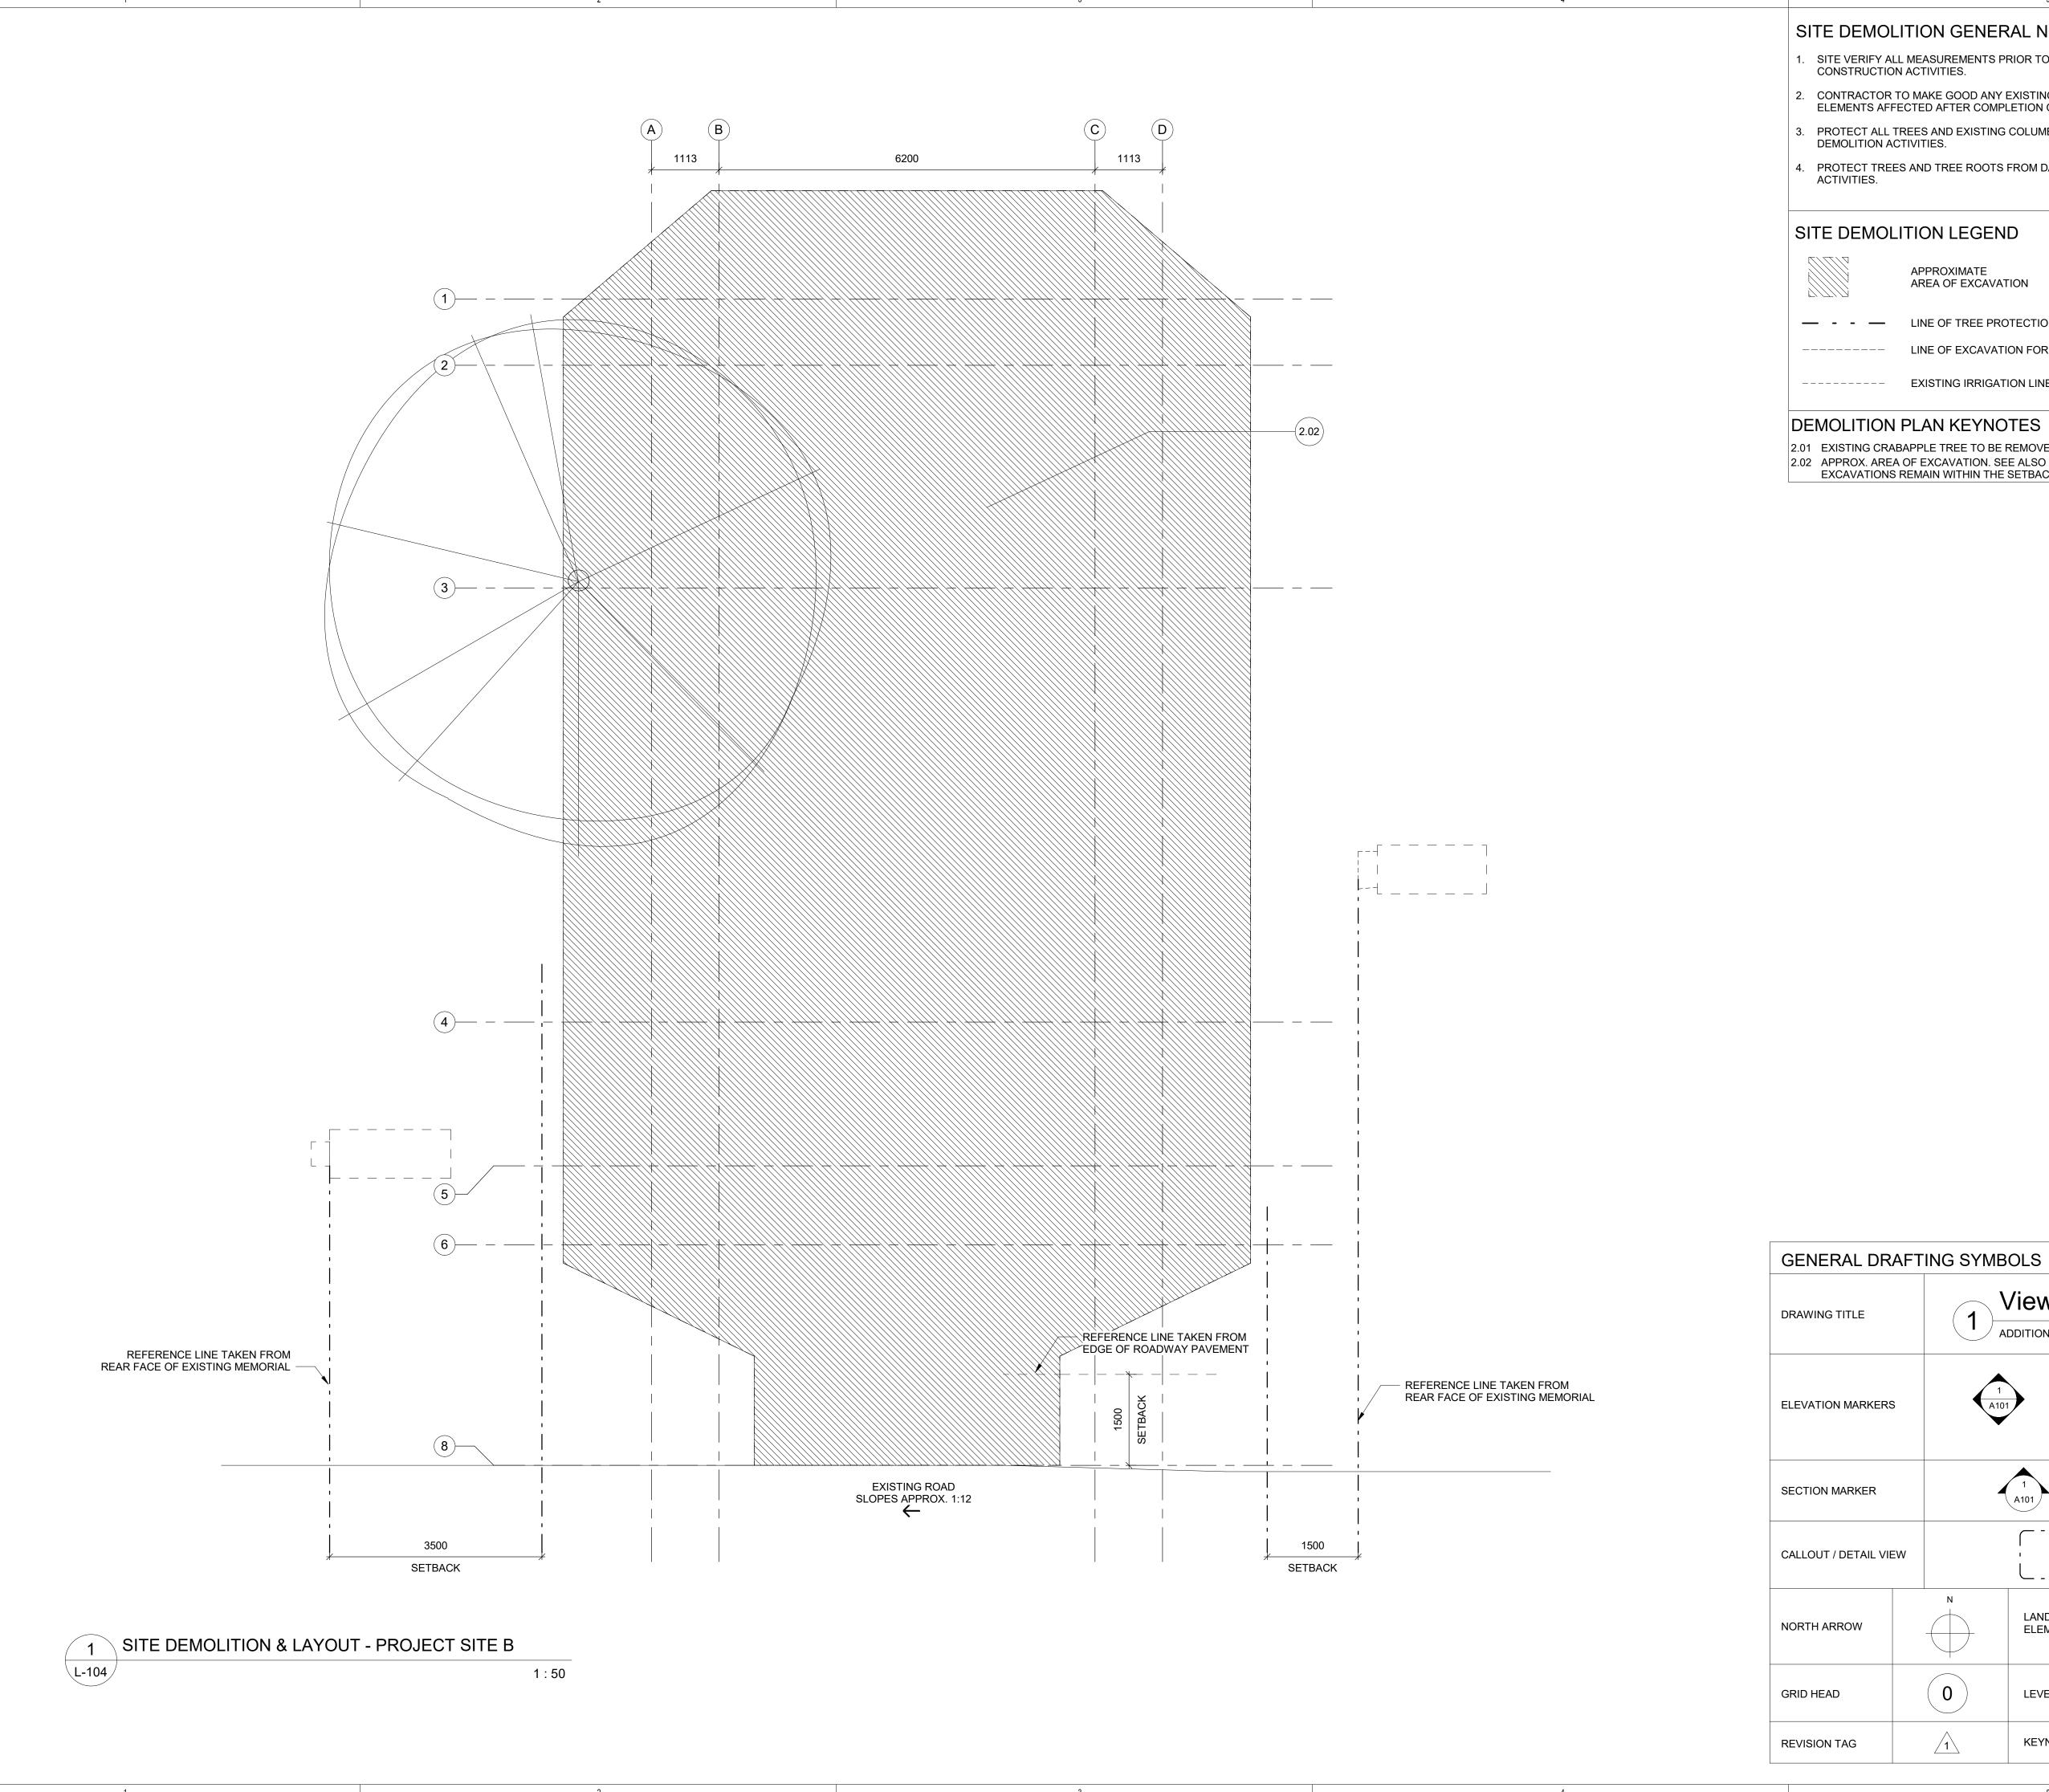
PROJECT NO: CITYE-18-01

DRAWING CONTENTS

GRADING &
LAYOUT PLANS PROJECT SITE A

SHEET NUMBER





#### SITE DEMOLITION GENERAL NOTES:

- 1. SITE VERIFY ALL MEASUREMENTS PRIOR TO COMMENCEMENT OF DEMOLITION OR CONSTRUCTION ACTIVITIES.
- 2. CONTRACTOR TO MAKE GOOD ANY EXISTING PATHWAY OR LANDSCAPE ELEMENTS AFFECTED AFTER COMPLETION OF CONSTRUCTION.
- 3. PROTECT ALL TREES AND EXISTING COLUMBARIA TO REMAIN IN PLACE DURING DEMOLITION ACTIVITIES.
- 4. PROTECT TREES AND TREE ROOTS FROM DAMAGE DURING EXCAVATION ACTIVITIES.

### SITE DEMOLITION LEGEND

APPROXIMATE AREA OF EXCAVATION

LINE OF EXCAVATION FOR WALKWAY

— - - LINE OF TREE PROTECTION HOARDING

---- EXISTING IRRIGATION LINE

#### DEMOLITION PLAN KEYNOTES

2.01 EXISTING CRABAPPLE TREE TO BE REMOVED BY CITY FORESTRY DEPT. 2.02 APPROX. AREA OF EXCAVATION. SEE ALSO STRUCTURAL PLANS. ENSURE EXCAVATIONS REMAIN WITHIN THE SETBACK LINES.

View Name

LANDSCAPE ELEMENT TAG

LEVEL HEAD

**KEYNOTE TAG** 

1

ADDITIONAL TEXT View Scale

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Mechanical:

Electrical:

**SEALS** 



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#### PROJECT TITLE MT PLEASANT **UNISTONE & MEMORIAL PLAZA**

MOUNT PLEASANT CEMENTERY 5420 106 ST N.W. EDMONTON, AB T6H 2S9

ISSUE: 2						
2	2020-03-19	ISSUED FOR TENDER				
1	2019-11-12	ISSUED FOR CLIENT REVIEW DESIGN				
No.	Date	Description				

SCALE: As indicated **DRAWN BY:** 

CHECKED BY/QA: JH

**PROJECT NO:** CITYE-18-05


DRAWING CONTENTS

SITE DEMOLITION - PROJECT SITE B

SHEET NUMBER

XX1

Name Elevation

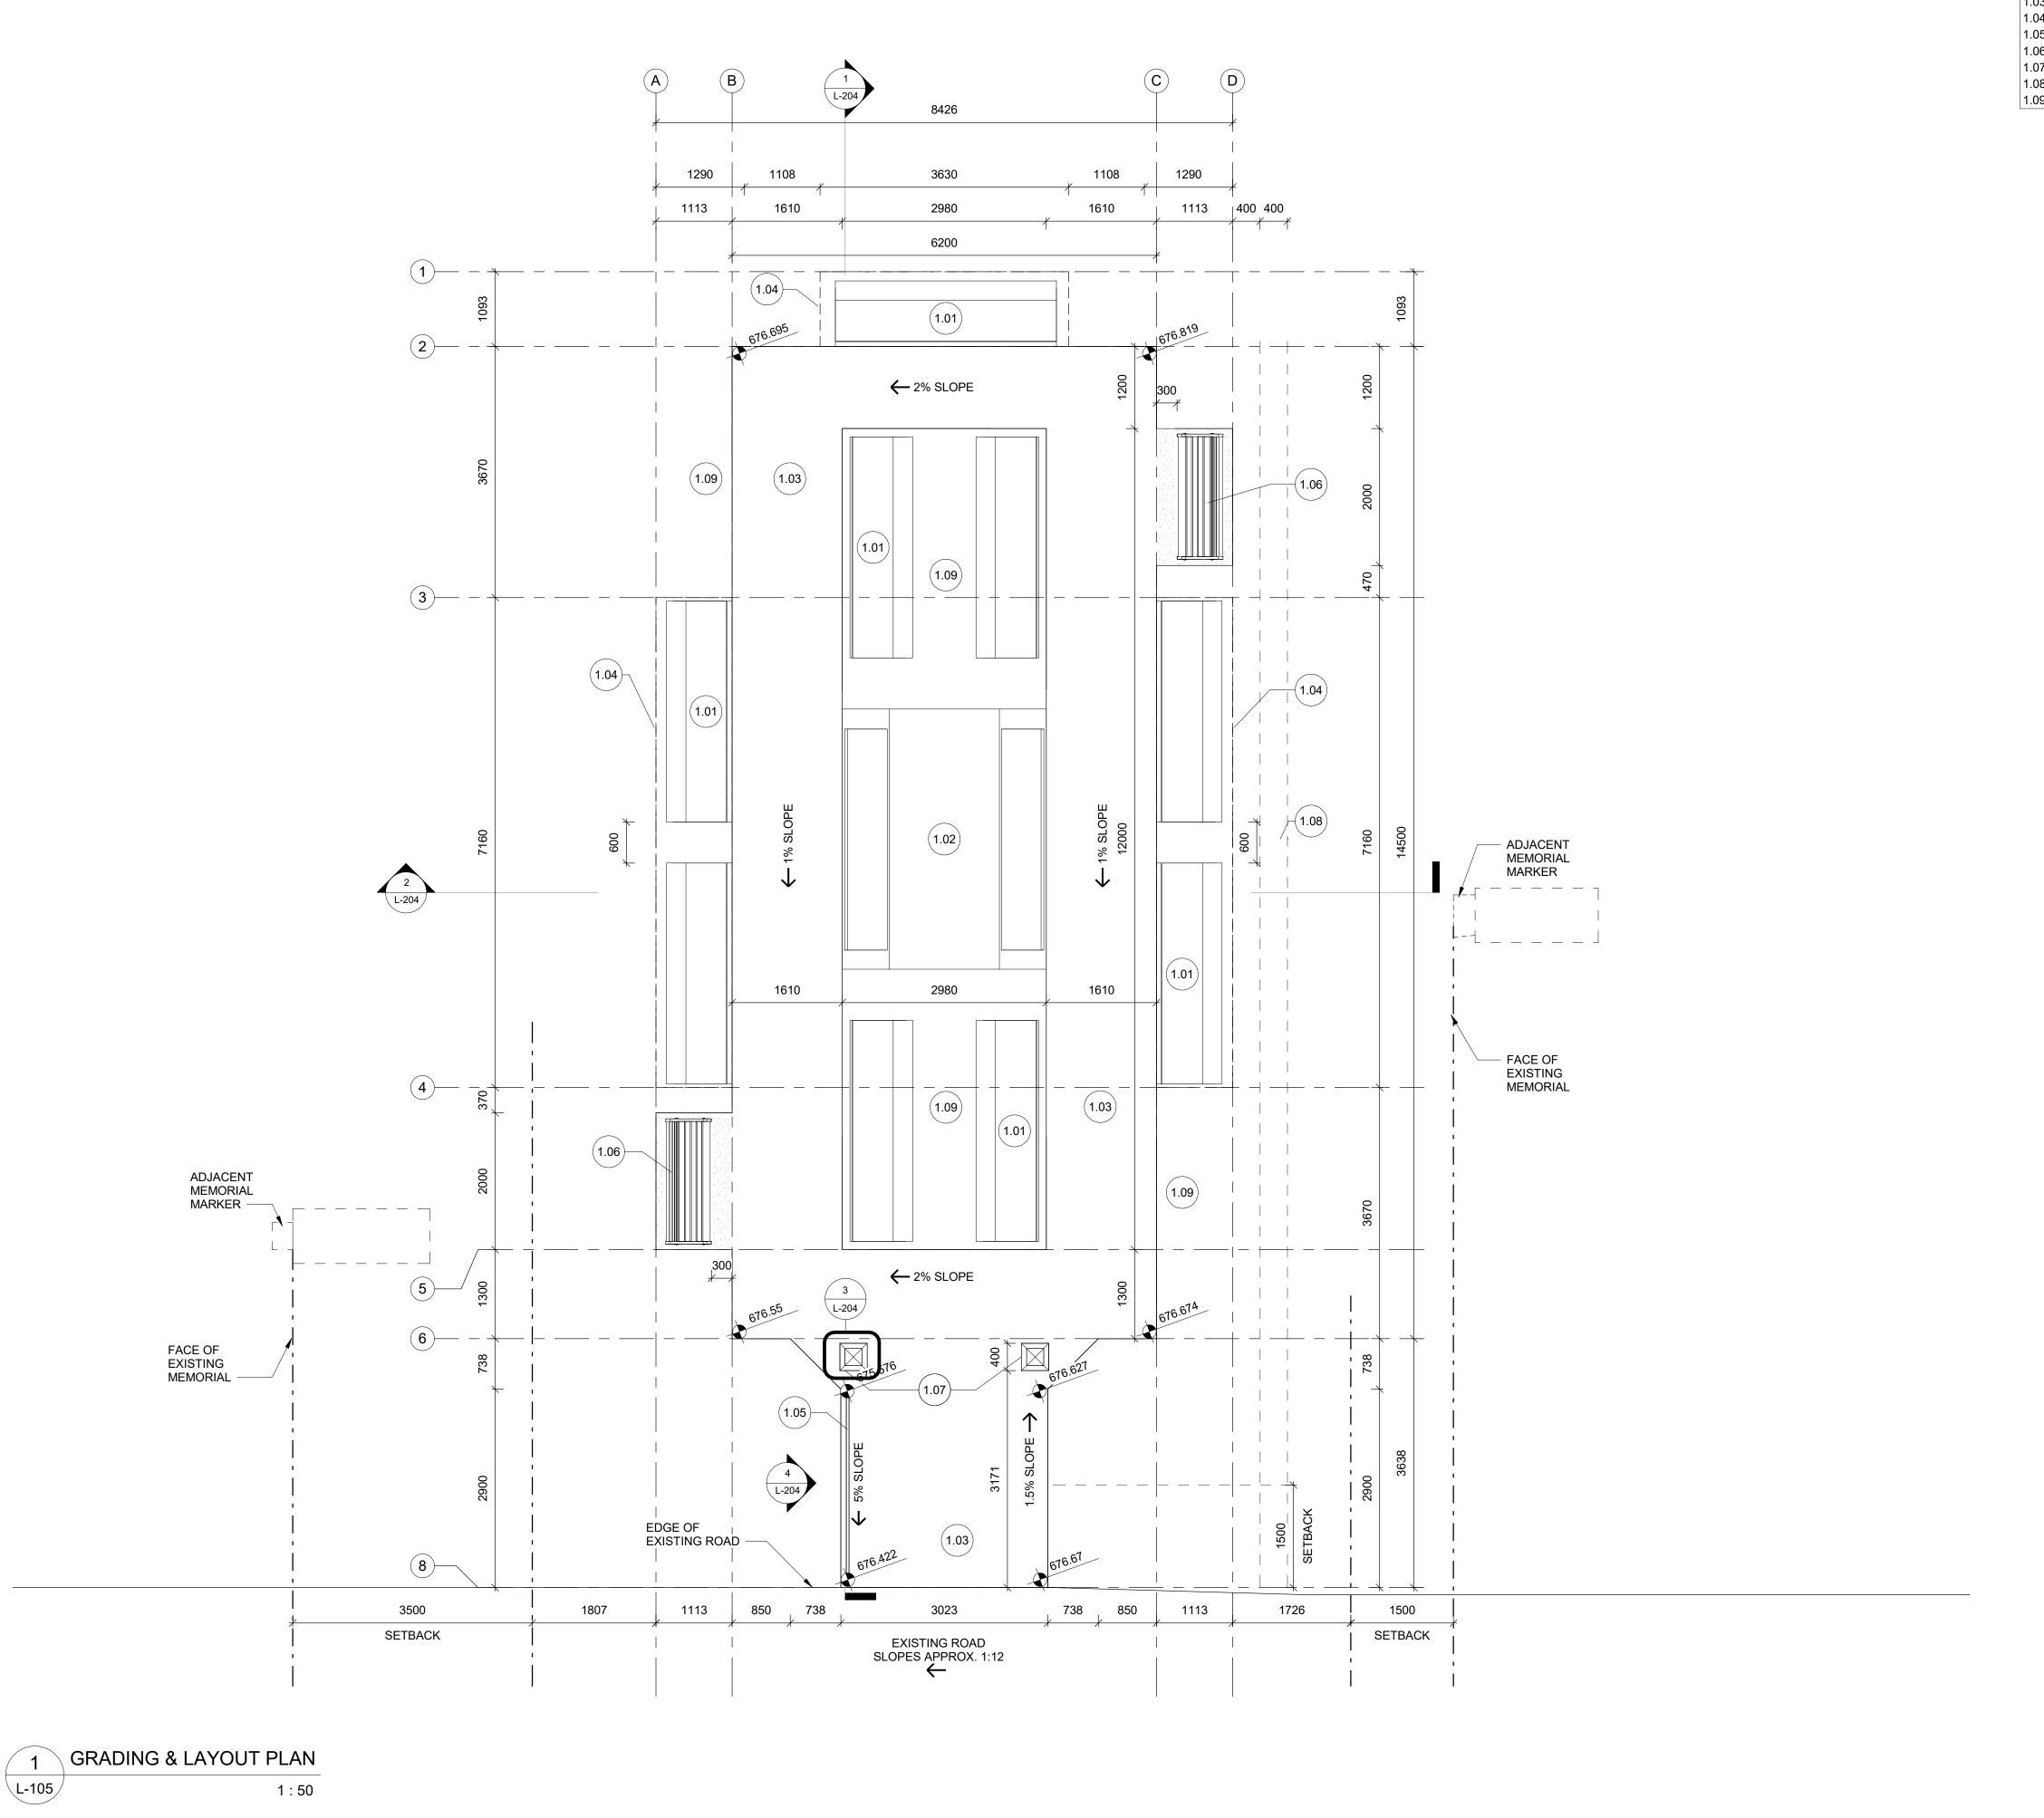

#### PLAN KEYNOTES

- 1.01 RELOCATED MEMORIAL NICHE
- 1.02 RELOCATED DUAL MEMORIAL NICHE
- 1.03 NEW CONCRETE SIDEWALK SLAB. REFER TO STRUCTURAL 1.04 LINE OF FOUNDATION SLAB, BELOW GRADE. REFER TO STRUCTURAL
- 1.05 PROVIDE HANDRAIL AS DETAILED.
- 1.06 INSTALL GARDEN BENCH PROVIDED BY OWNER, ON CONCRETE SIDEWALK SLAB

- 1.07 ENTRY MARKERS. SEE DETAIL

- 1.08 PROPOSED SWALE, SLOPED TO DRAIN AWAY FROM PLAZA. SEE PLANTING PLAN 1.09 PROVIDE GROWING MEDIUM AND LANDSCAPE MATERIALS BETWEEN NICHES.

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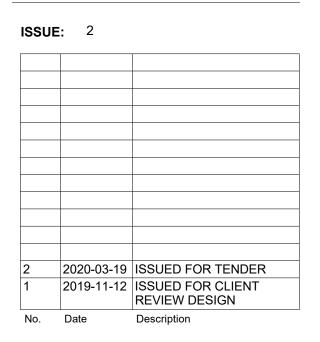
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PROJECT TITLE **MT PLEASANT UNISTONE & MEMORIAL PLAZA** 

MOUNT PLEASANT CEMENTERY 5420 106 ST N.W. EDMONTON, AB T6H 2S9



1:50

SCALE:

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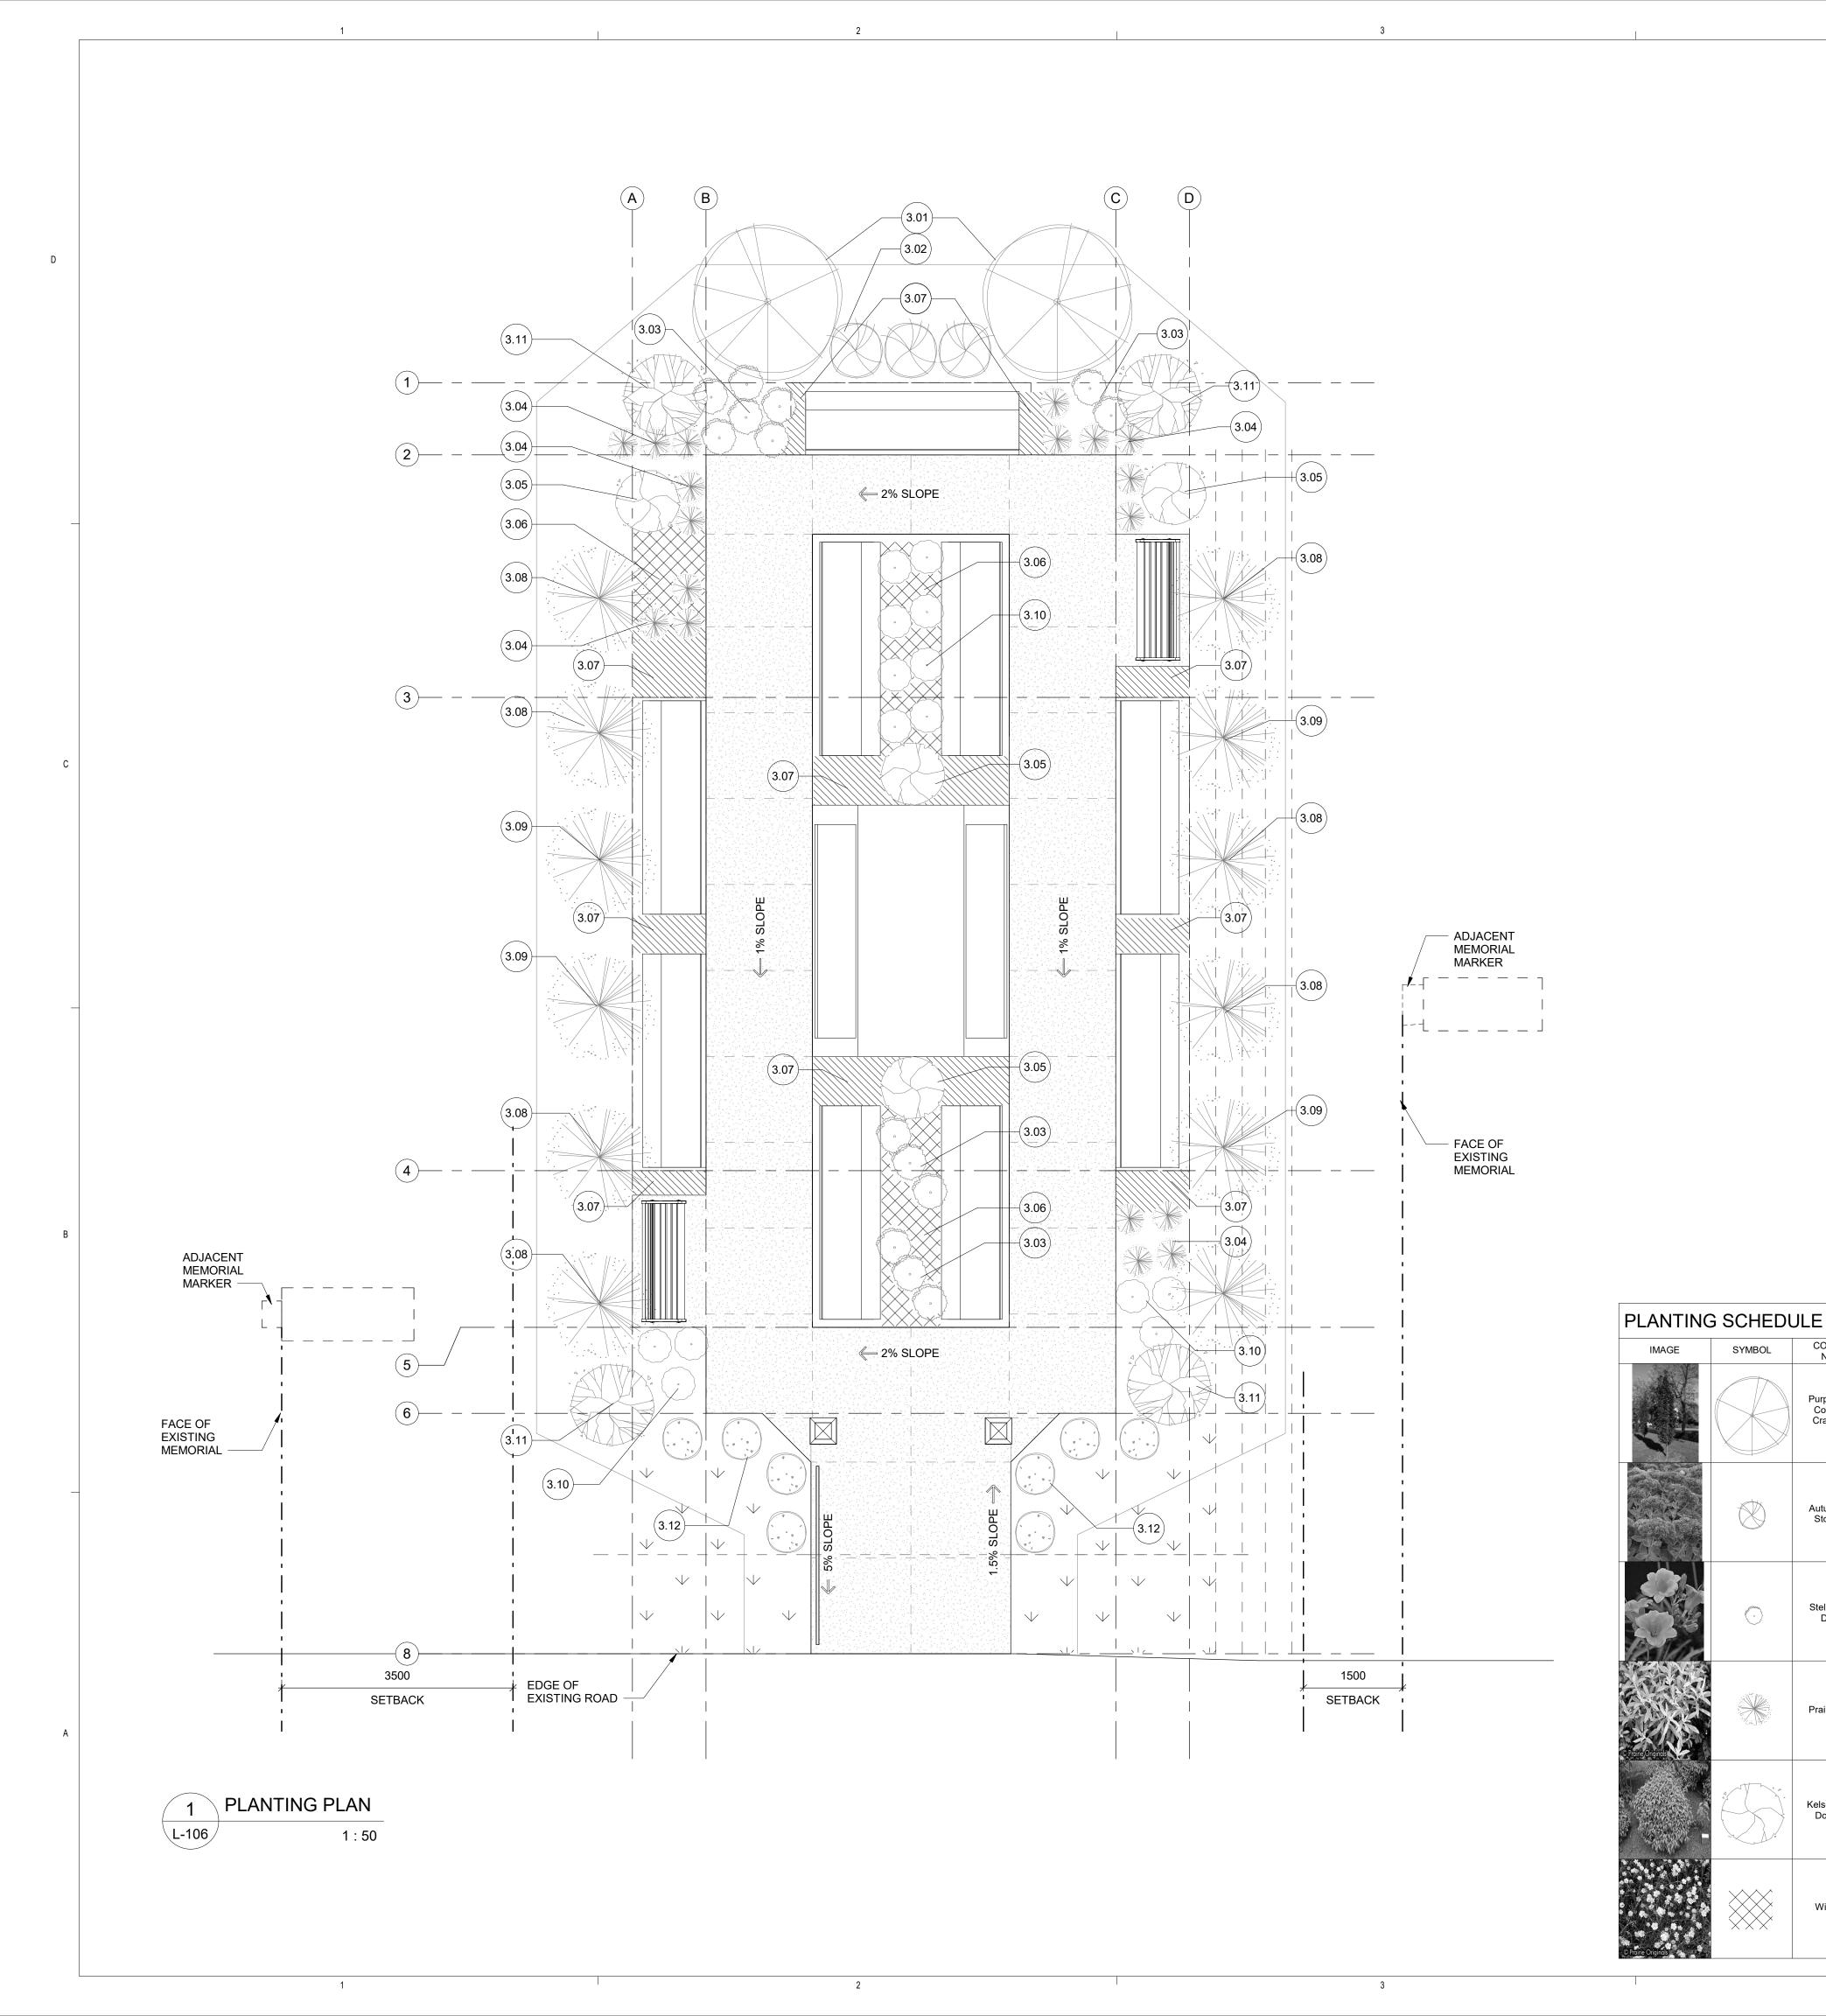
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CITYE-18-05 PROJECT NO:

DRAWING CONTENTS

**GRADING & LAYOUT PLAN -**PROJECT SITE B

SHEET NUMBER



#### PLANTING KEYNOTES

- 3.02 AUTUMN FIRE STONECROP
- 3.03 STELLA D'ORO DAYLILY
- 3.04 PRAIRIE SAGE
- 3.05 KELSEY DWARF DOGWOOD 3.06 WILD FLAX
- 3.07 BEARBERRY

COMMON NAME

Purple Spire Columnar Crabapple

Stella D'Oro Daylily

Prairie Sage

Kelsey Dwarf

SCIENTIFIC NAME

Malus 'Jefspire'

Hemerocallis 'Stella

de Oro'

Ludoviciana

Cornus Sericea

Linum Lewisii

SIZE + SPREAD QUANTITY SPACING (mm)

7.9 m 2440

600 460

450

300 300-500

914 914

250-500 250

- 3.08 PRINCE OF WALES JUNIPER
- 3.09 DOUBLE FROSTED JUNIPER
- 3.10 NIGHT BEACON D'ORO 3.11 DWARF KOREAN LILAC
- 3.12 MOCK ORANGE

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**SEALS** 




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MOUNT PLEASANT CEMENTERY 5420 106 ST N.W. EDMONTON, AB T6H 2S9



CHECKED BY/QA: JH

DRAWN BY:

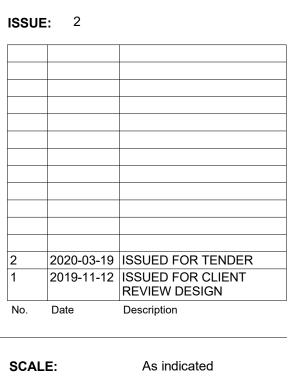SCIENTIFIC SIZE + SPREAD NAME SPACING (mm) QUANTITY

180 2135

100

1220

1220 4

landscape

Arctostaplylos uva-

Juniperus Horizontalis 'Prince

of Wales'

Hemerocallis 'Night

Syringa meyeri 'Palibin' (tree form)

COMMON

NAME

Daub's Frosted

Night Beacon D'Oro

Dwarf Korean Lilac

Mock Orange


SYMBOL

**PROJECT NO:** CITYE-18-05

DRAWING CONTENTS

### **PLANTING PLAN -**PROJECT SITE B

SHEET NUMBER

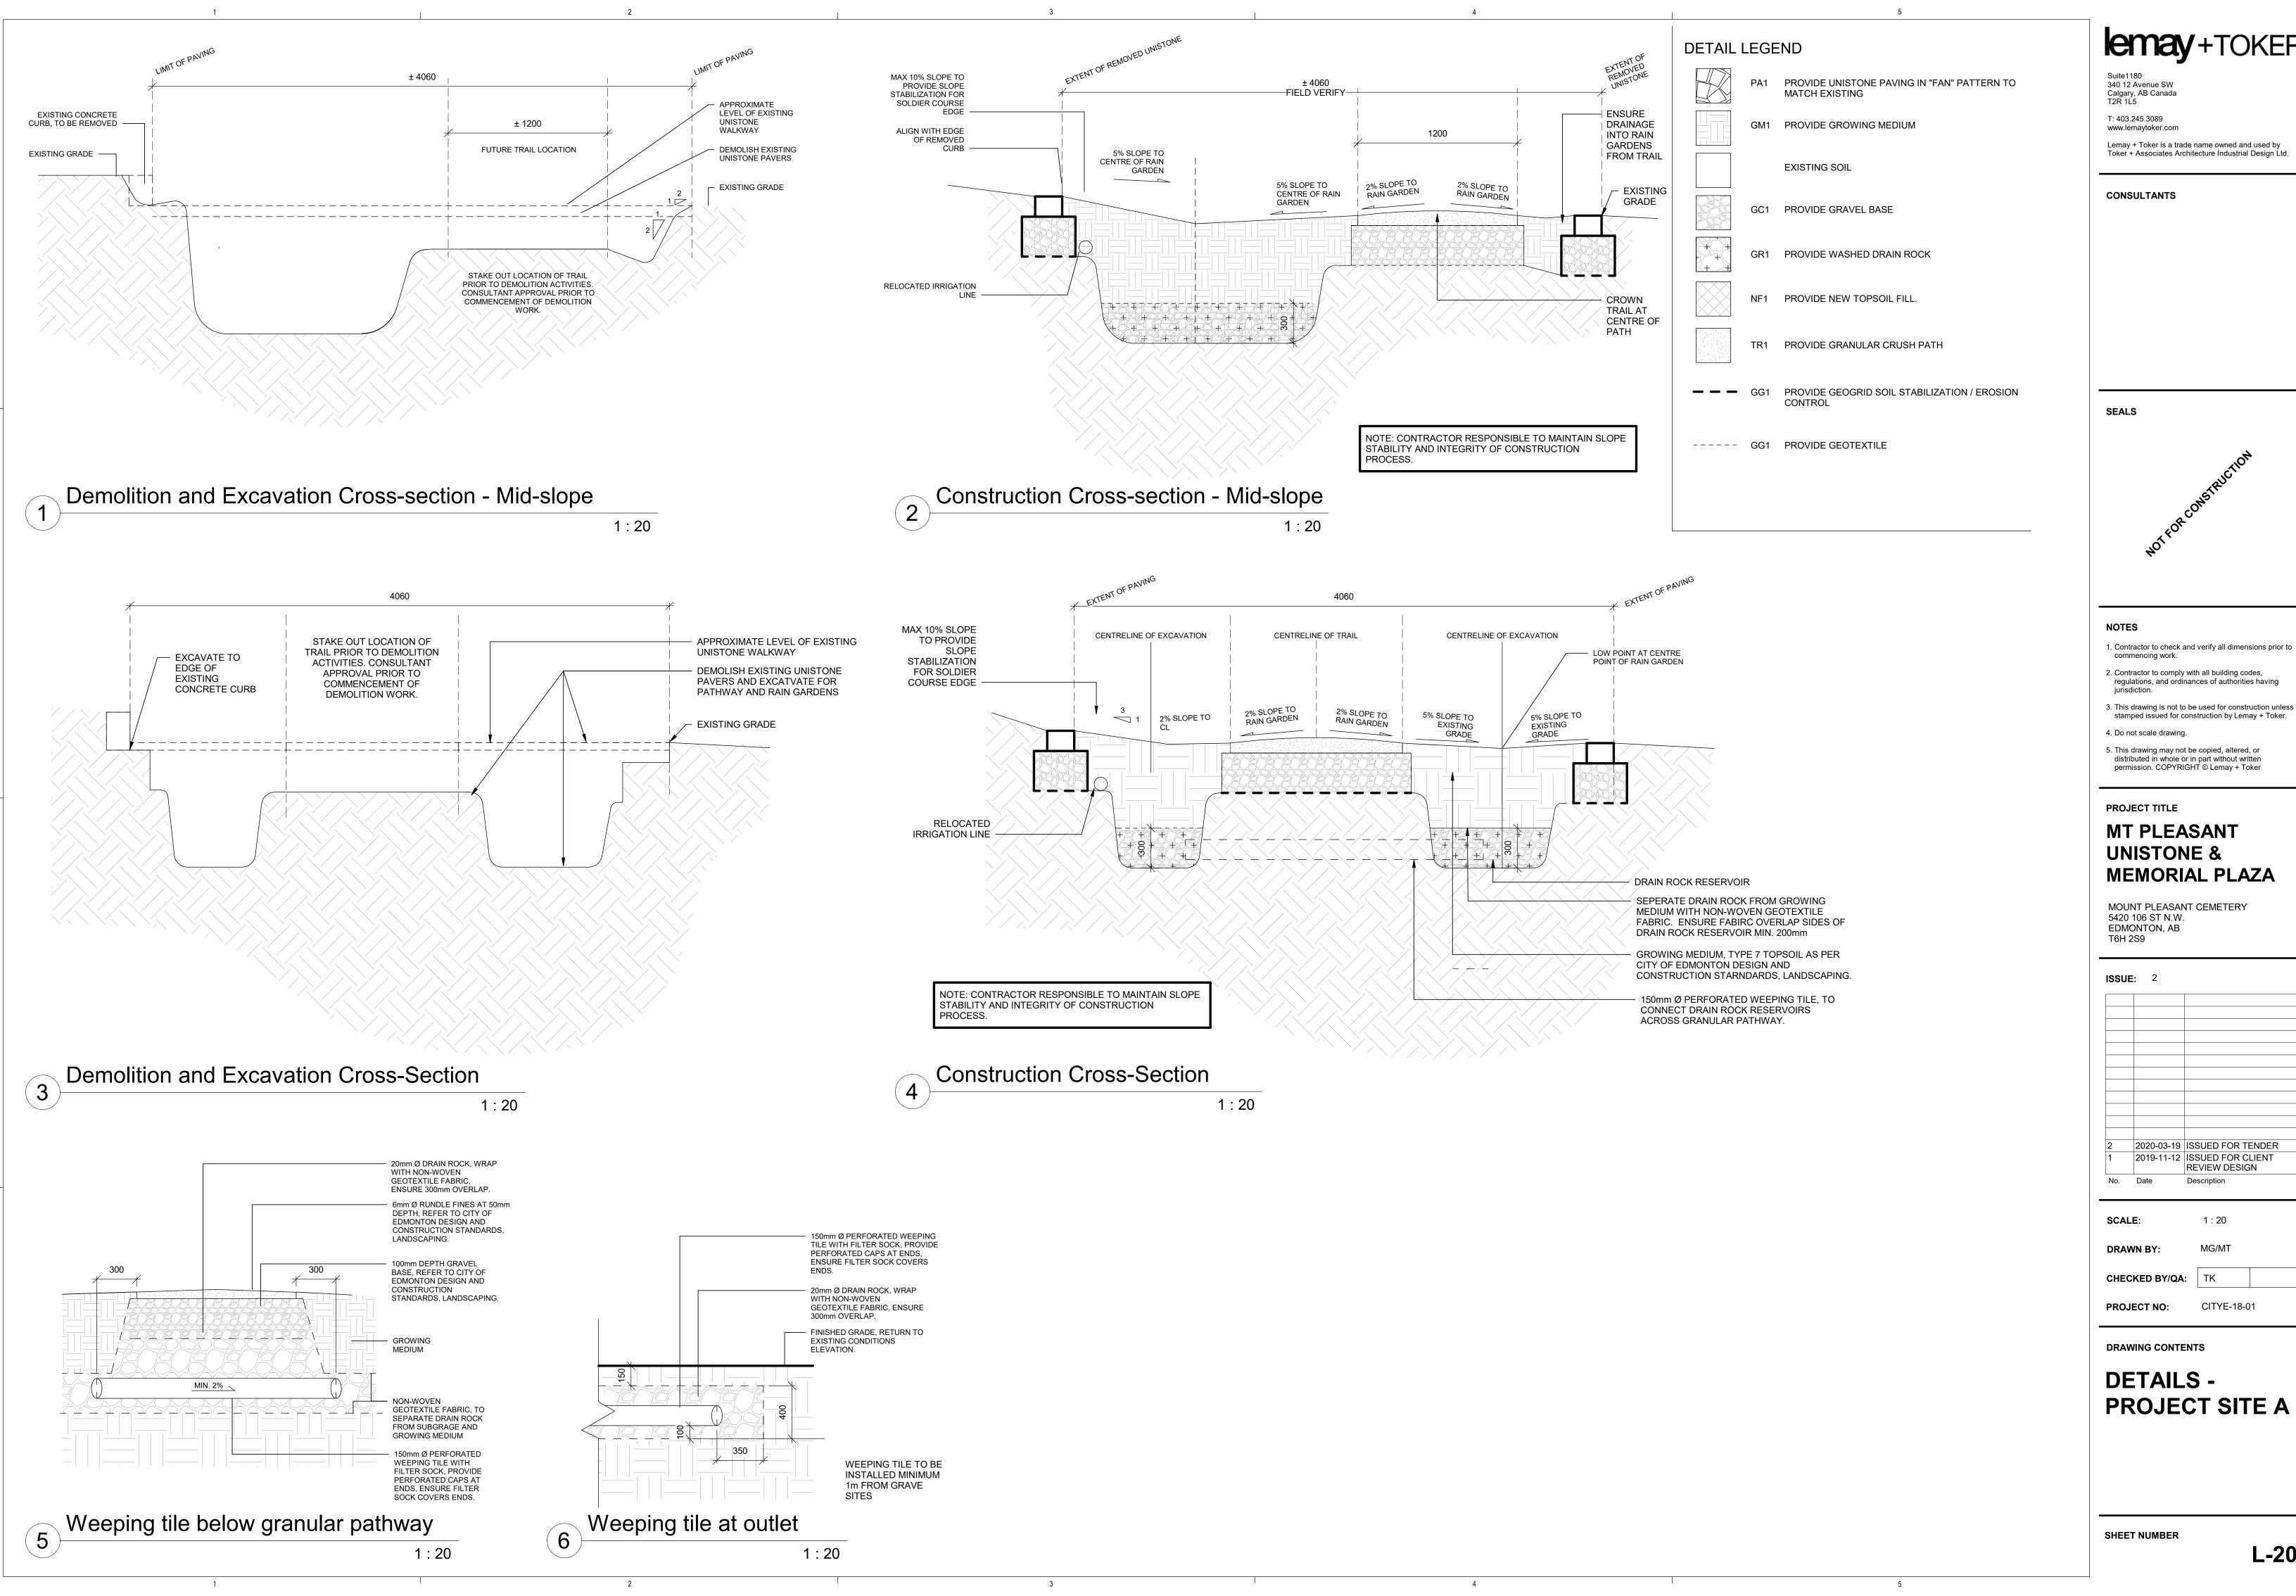

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### **MT PLEASANT UNISTONE & MEMORIAL PLAZA**

MOUNT PLEASANT CEMETERY 5420 106 ST N.W. EDMONTON, AB

2020-03-19 ISSUED FOR TENDER 2019-11-12 ISSUED FOR CLIENT REVIEW DESIGN

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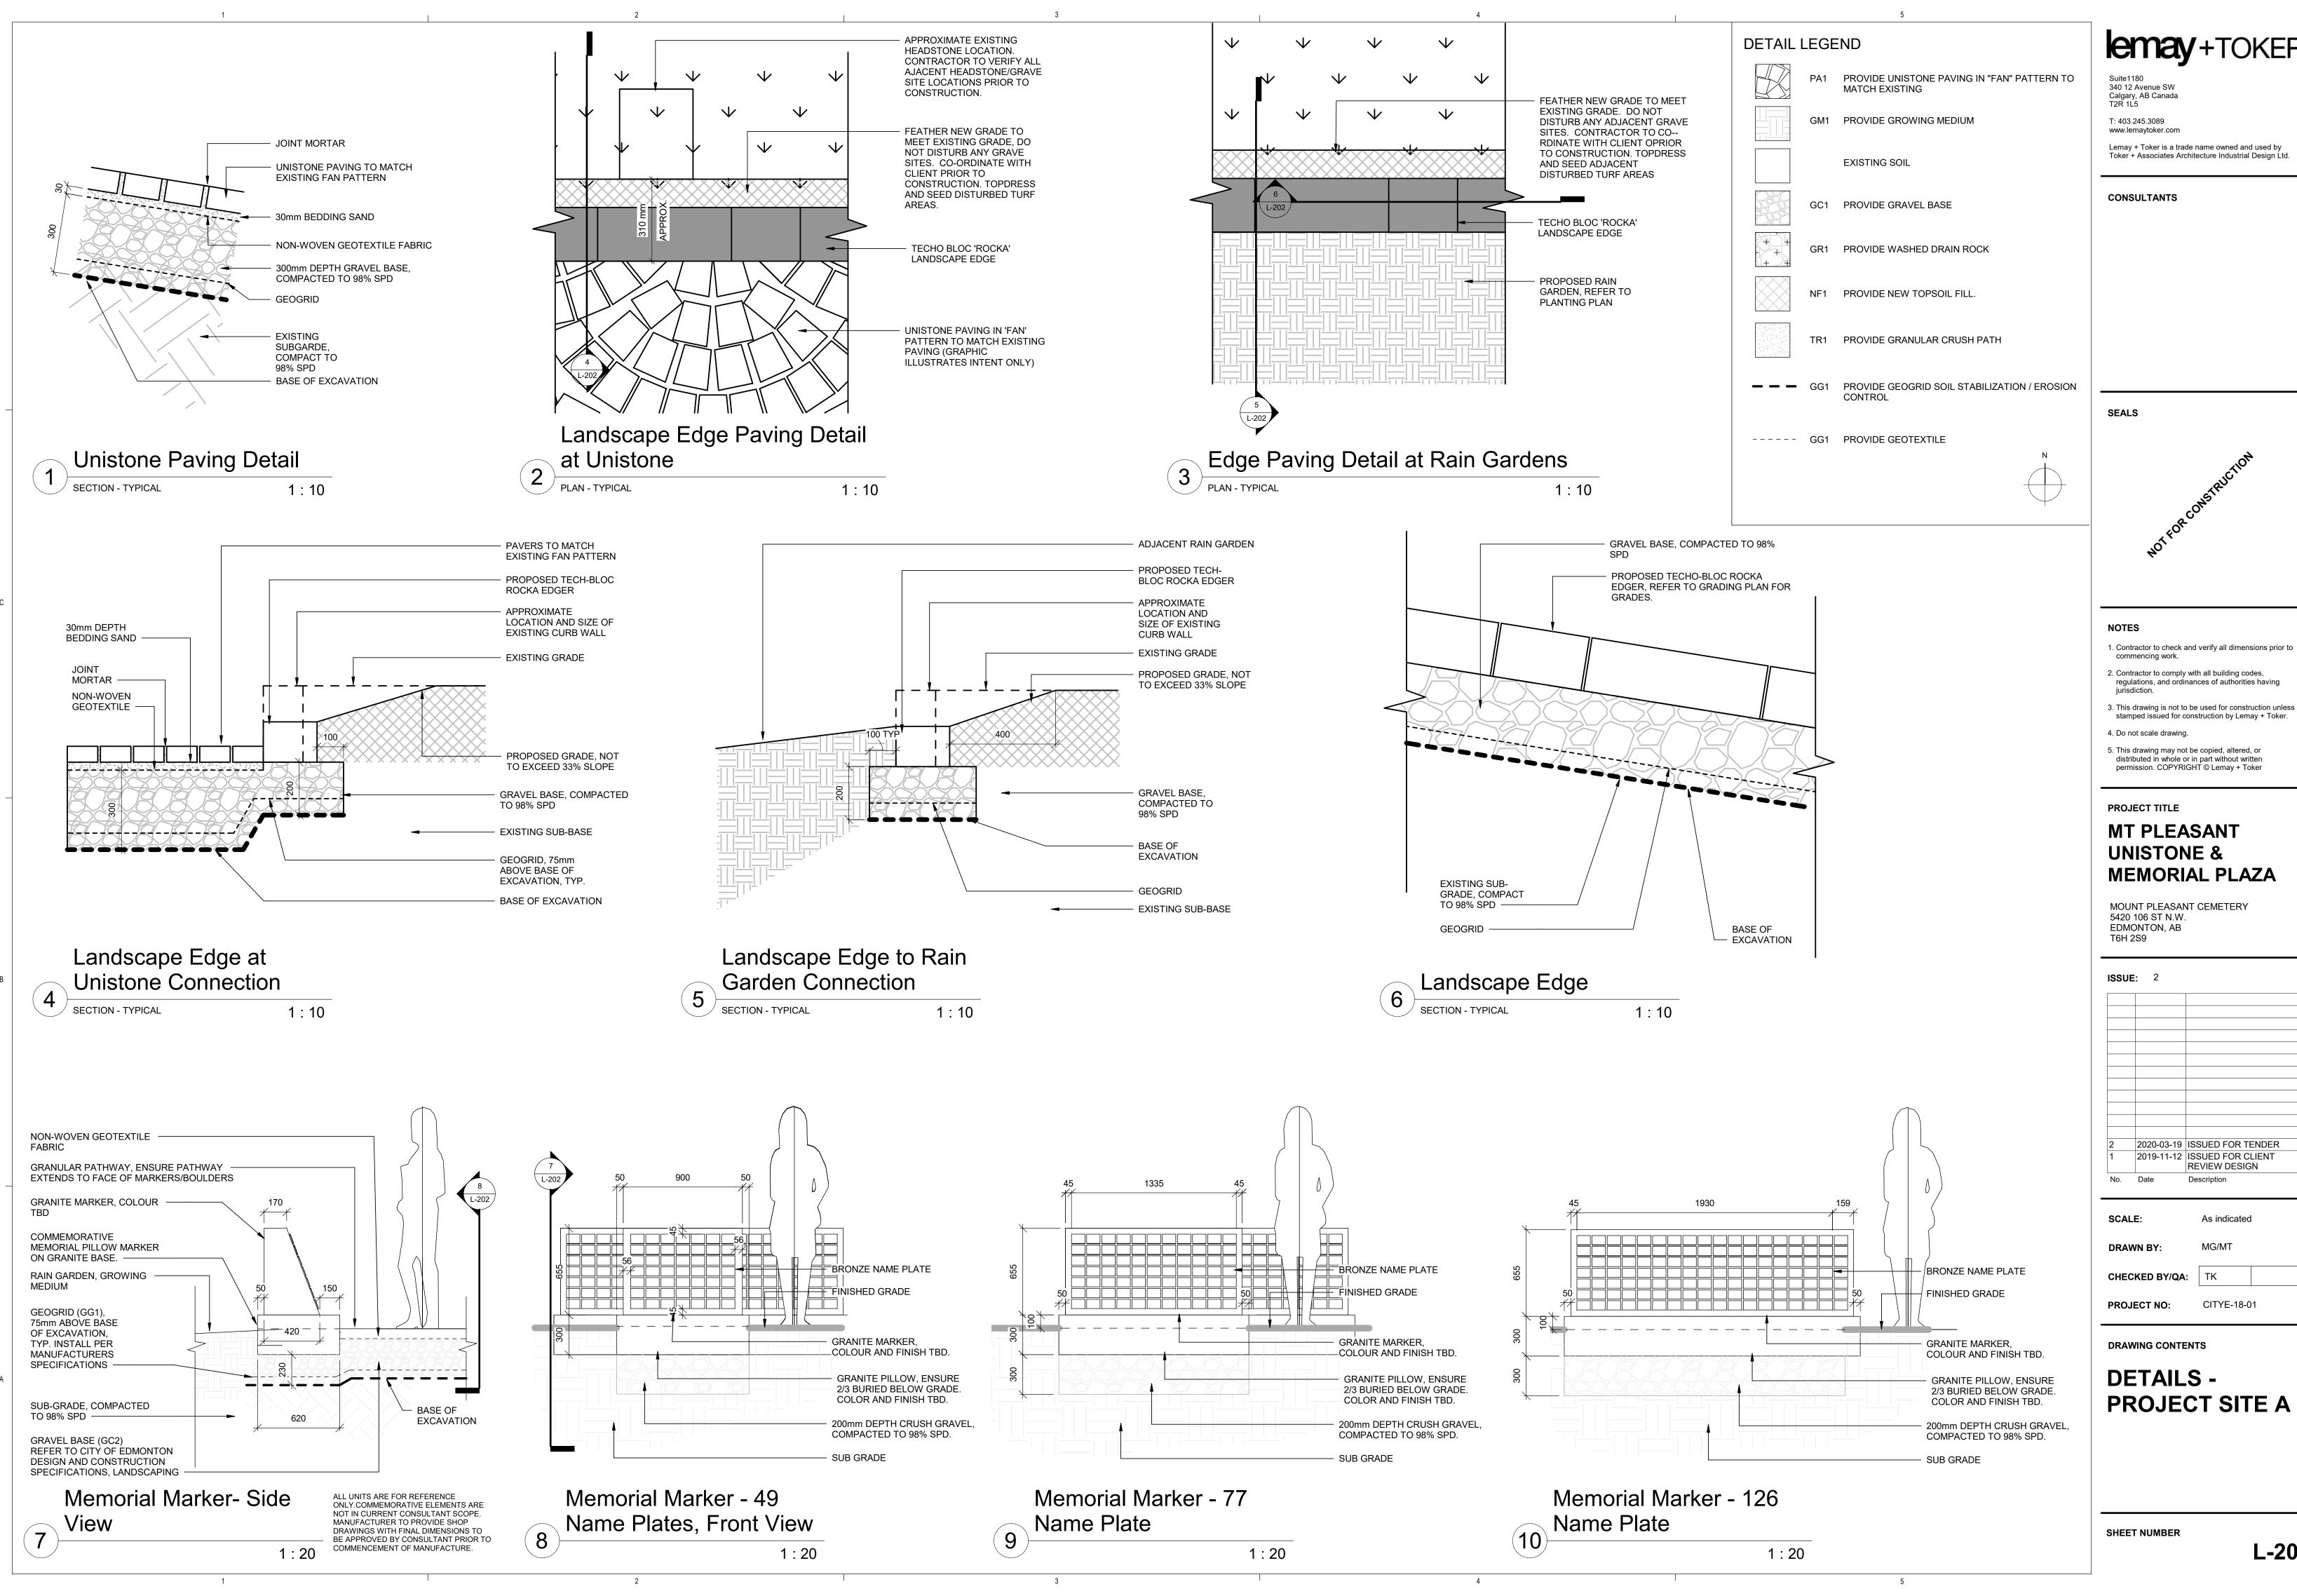
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DRAWING CONTENTS

**PROJECT SITE A** 

CITYE-18-01

SHEET NUMBER



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### **UNISTONE & MEMORIAL PLAZA**

MOUNT PLEASANT CEMETERY


2020-03-19 ISSUED FOR TENDER 2019-11-12 ISSUED FOR CLIENT REVIEW DESIGN


As indicated

MG/MT

CITYE-18-01

**PROJECT SITE A** 

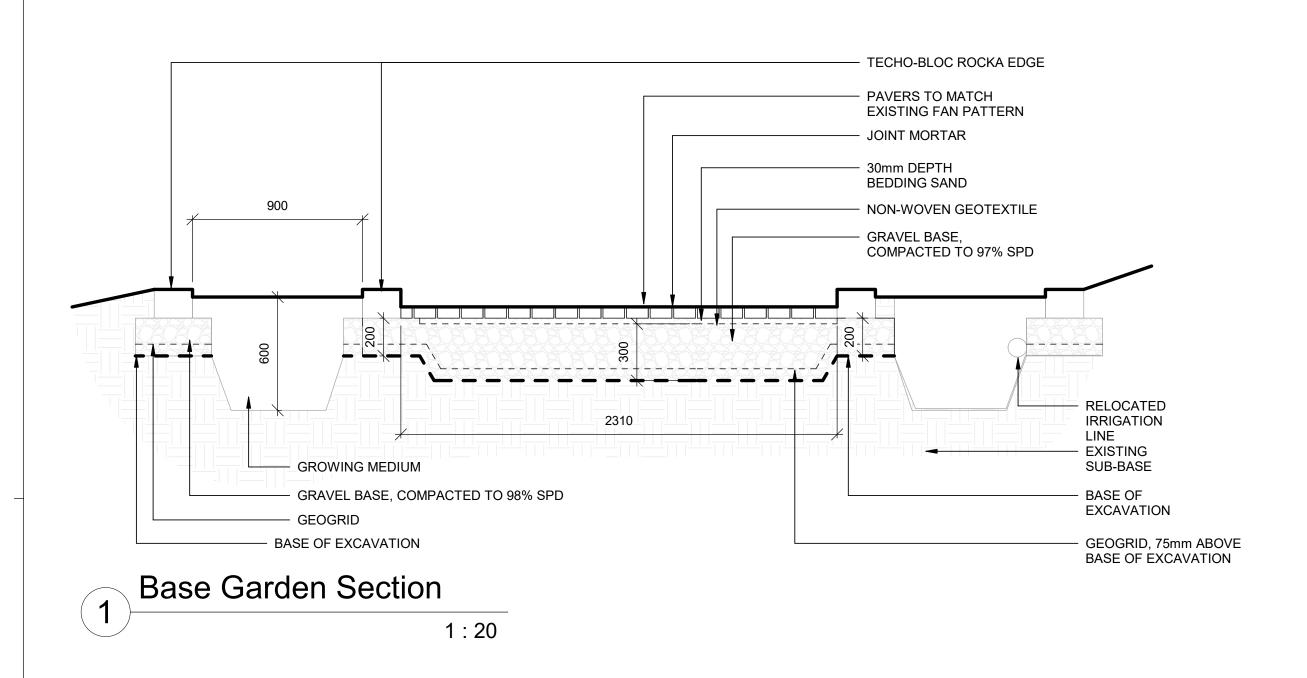

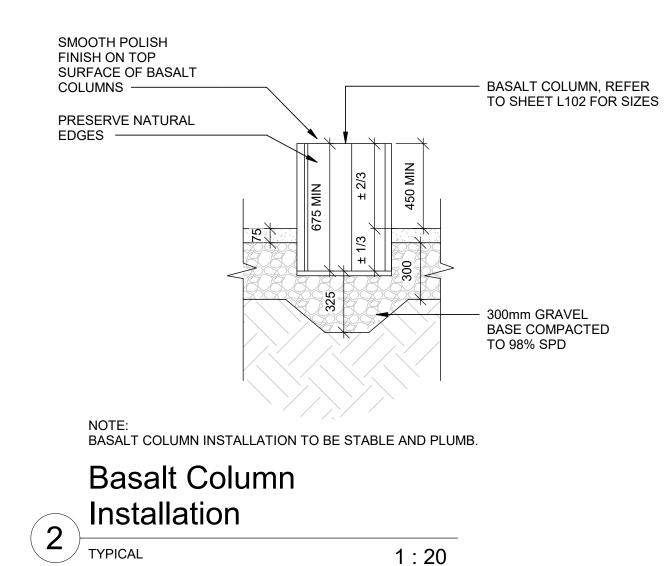

1:20

Suite1180 340 12 Avenue SW Calgary, AB Canada T2R 1L5

T: 403.245.3089 www.lemaytoker.com

Lemay + Toker is a trade name owned and used by Toker + Associates Architecture Industrial Design Ltd.

CONSULTANTS

**SEALS** 



#### NOTES

- 1. Contractor to check and verify all dimensions prior to commencing work.
- Contractor to comply with all building codes, regulations, and ordinances of authorities having jurisdiction.
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PROJECT TITLE

### MT PLEASANT **UNISTONE & MEMORIAL PLAZA**

MOUNT PLEASANT CEMETERY 5420 106 ST N.W. EDMONTON, AB T6H 2S9

ISSUE: 2 2 2020-03-19 ISSUED FOR TENDER 1 2019-11-12 ISSUED FOR CLIENT REVIEW DESIGN

1:20

SCALE:

DRAWN BY:


CHECKED BY/QA: Checker

PROJECT NO: CITYE-18-01

DRAWING CONTENTS

**DETAILS -**PROJECT SITE A

SHEET NUMBER

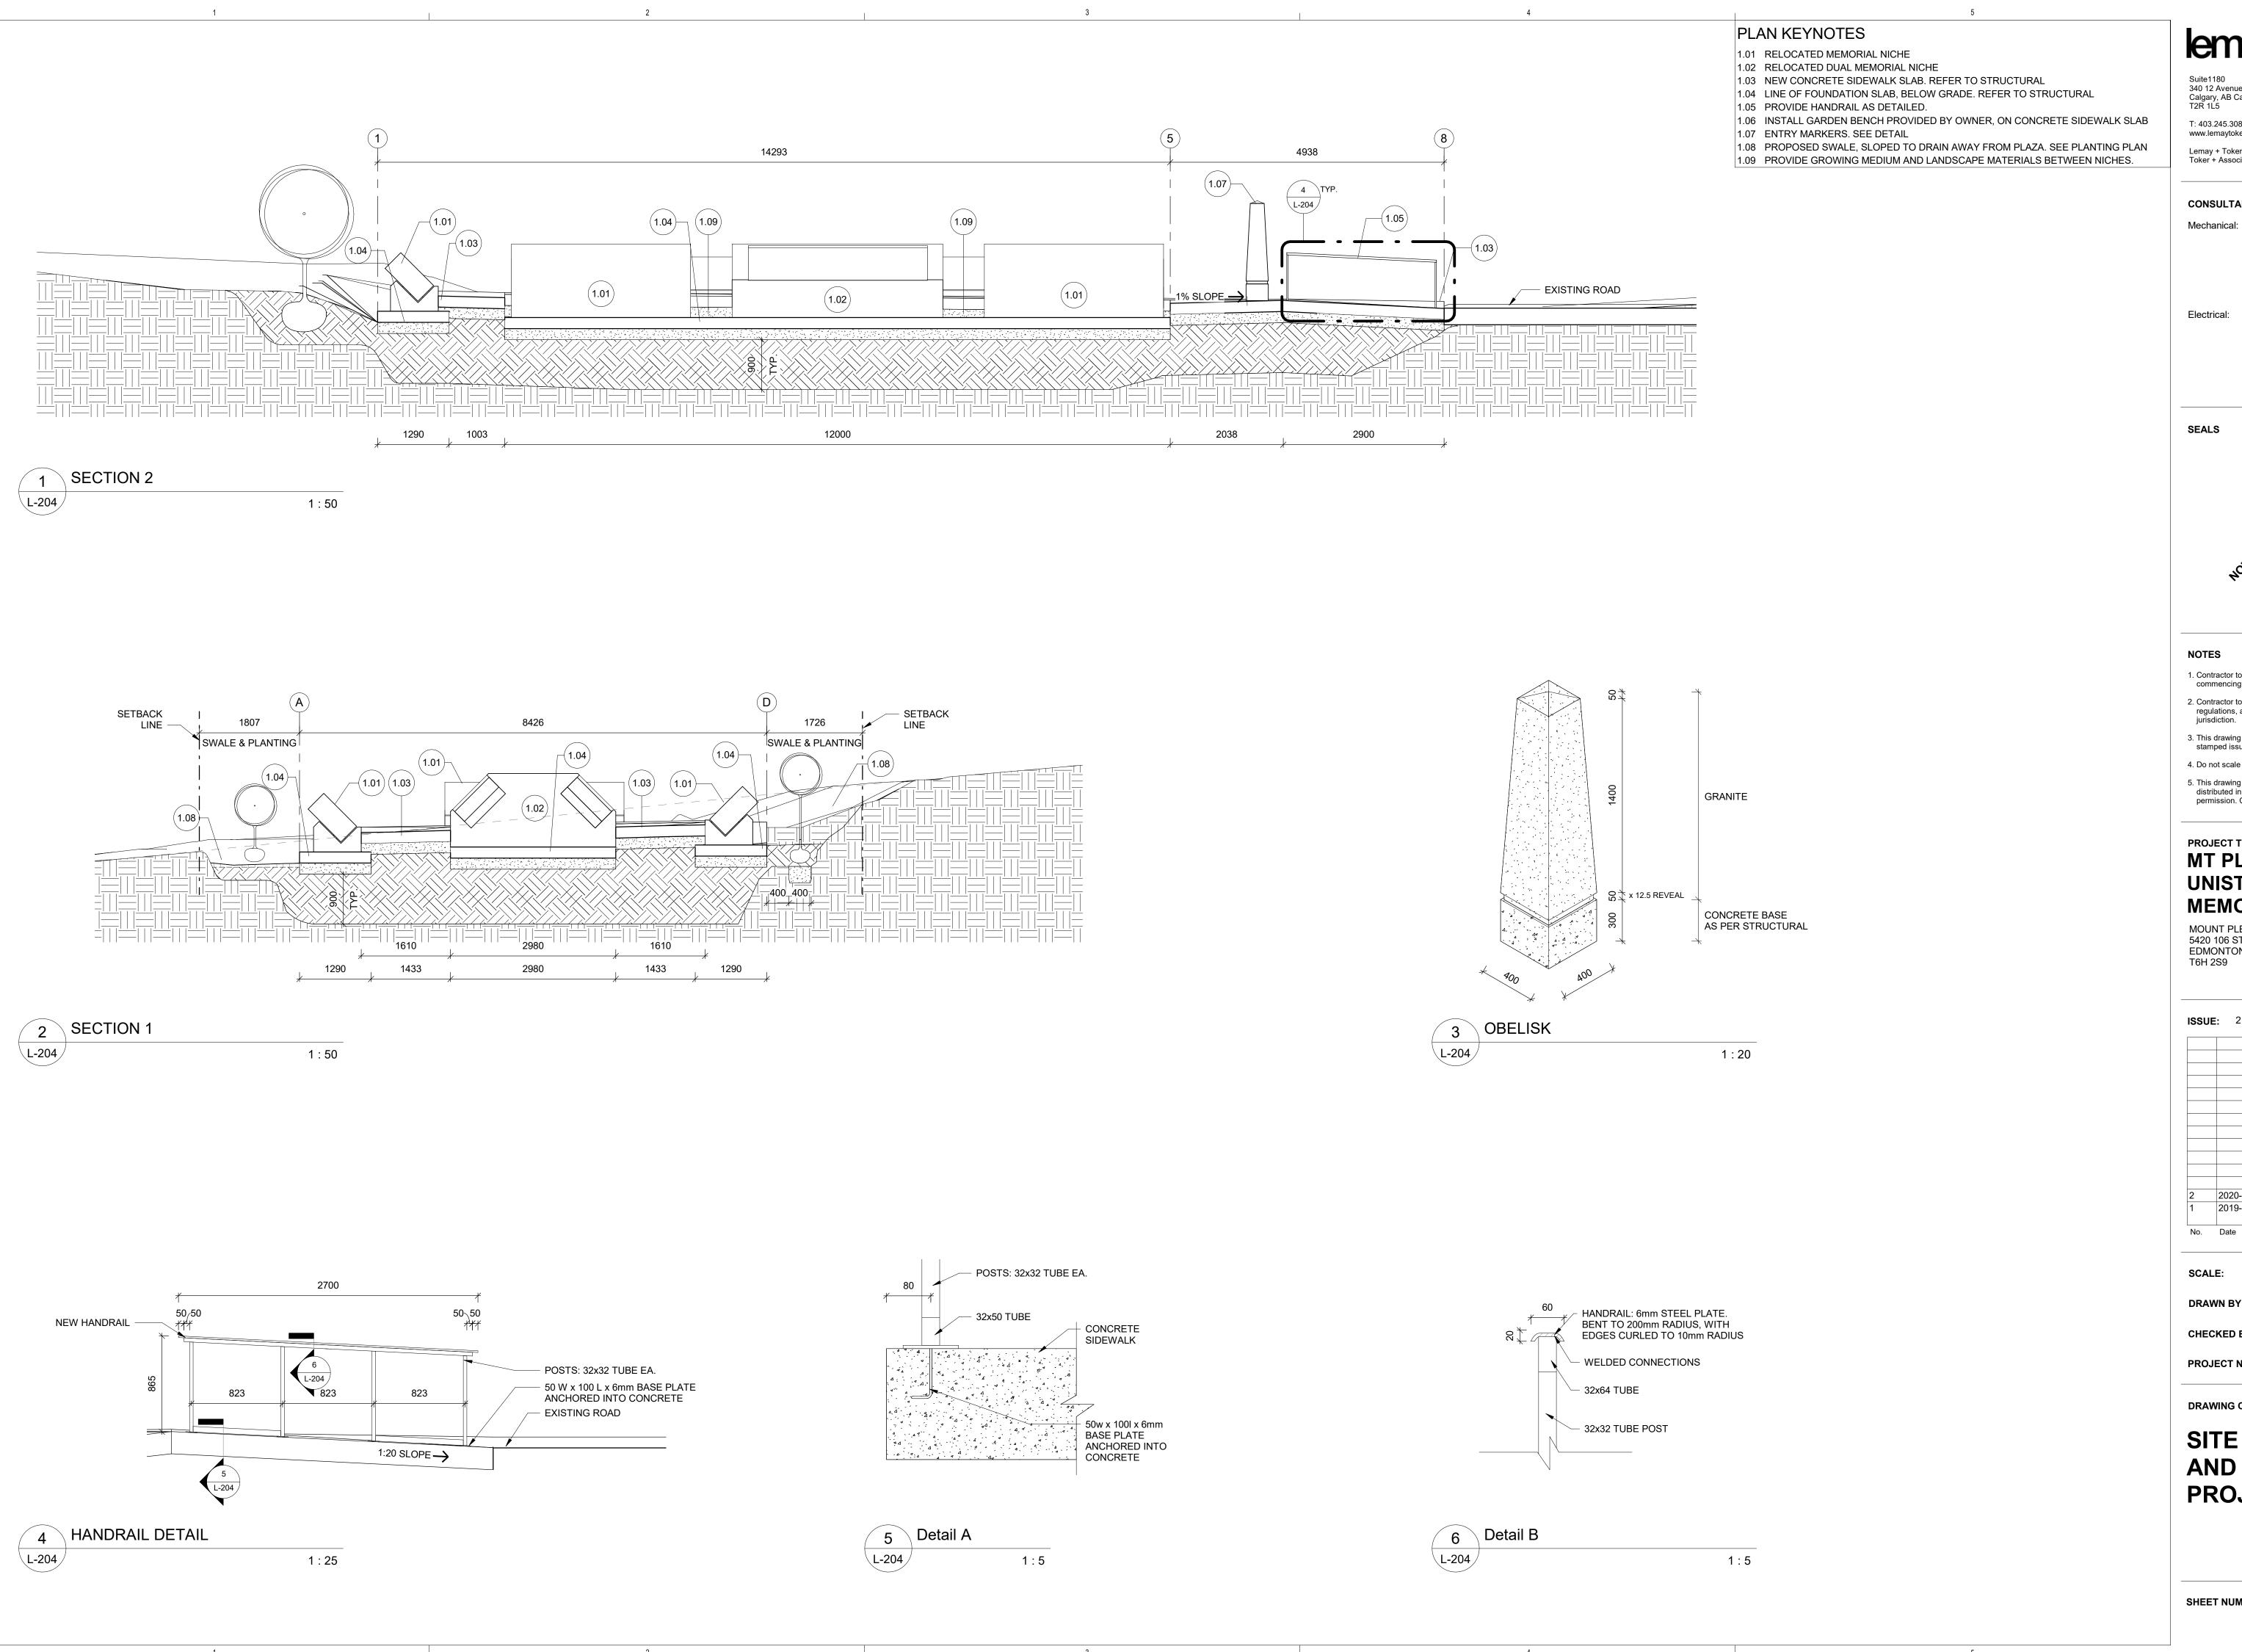

lemay+TOKER


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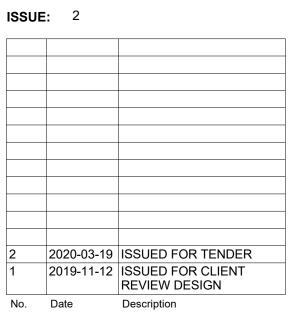
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PROJECT TITLE

### MT PLEASANT **UNISTONE & MEMORIAL PLAZA**

MOUNT PLEASANT CEMENTERY 5420 106 ST N.W. EDMONTON, AB T6H 2S9



SCALE: As indicated

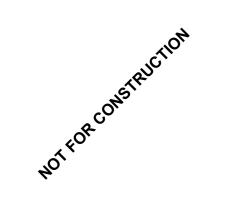DRAWN BY:

CHECKED BY/QA: JH

PROJECT NO: CITYE-18-05

DRAWING CONTENTS

SITE SECTIONS

**AND DETAILS -PROJECT B** 

SHEET NUMBER